

CASE # 11

**CITY OF AUSTIN
APPLICATION TO SIGN REVIEW BOARD
SIGN VARIANCE**

WARNING: Filing of this appeal stops all affected construction activity.

PLEASE: TYPE AND COMPLETE ALL REQUESTED INFORMATION.

STREET ADDRESS: 12221 N Mo-Pac Expressway Austin, TX 78758

LEGAL DESCRIPTION: Subdivision – 36.3670 A

Lot(s) 1 Block B Outlot Centrum Division The Resub of Blk B & E

I/We Michael A. Hunter on behalf of myself/ourselves as authorized agent for
St. David's North Austin Medical Center affirm that on October, 2014, hereby apply for a hearing before
the Sign Review Board for consideration:

ERECT – ATTACH – COMPLETE – REMODEL – MAINTAIN

Erect a new monument directional sign

in a _____ zoning district and located within the Scenic Roadway
Sign District.

If your variance request is for a reduction in setbacks or height limits, please contact Eben Kellogg with the Electric Utility at (512)322-6050 and send him a scan of your request to eben.kellogg@austinenergy.com before filing your application with this office to discuss your request. The Electric Utility will recommend the board deny your request if it will result in an encroachment into an electric easement or a NESC violation.

NOTE: The Board must determine the existence of, sufficiency of and weight of evidence supporting the findings described below. In order to grant your request for a variance, the Board must first make one or more of the findings described under 1, 2, and 3 below; the Board must then make the finding described in item 4 below. If the Board cannot make the required findings, it cannot approve a sign variance.

Therefore, you must complete each of the applicable Findings Statements as part of your application. Failure to do so may result in your application being rejected as incomplete. Please attach any additional support documents.

VARIANCE FINDINGS: I contend that my entitlement to the requested variance is based on the following findings:

1. The variance is necessary because strict enforcement of the Article prohibits any reasonable opportunity to provide adequate signs on the site, considering the unique features of a site such as its dimensions, landscaping, or topography, because: The new proposed sign is of the same type and design as previously approved signs for this property in Phase 1 approximately 2 years ago.

OR,

2. The granting of this variance will not have a substantially adverse impact upon neighboring properties, because: We are replacing an existing sign of the same nature in the same location.

OR,

3. The granting of this variance will not substantially conflict with the stated purposes of this sign ordinance, because: The additional size is needed to convey directions to various medical facilities within the campus

AND,

4. Granting a variance would not provide the applicant with a special privilege not enjoyed by others similarly situated or potentially similarly situated, because: This is an emergency medical facility that needs to be able to convey directional information to those in need of emergency medical care.

APPLICANT CERTIFICATE – I affirm that my statements contained in the complete application are true and correct to the best of my knowledge and belief.

Signed Michael A. Hunter Mail Address 7733 Harwell St

City, State & Zip Fort Worth, Texas 76108

Printed Michael A Hunter Phone 817-246-4848 Date 10/30/2014

OWNERS CERTIFICATE – I affirm that my statements contained in the complete application are true and correct to the best of my knowledge and belief.

Signed Michael A. Hunter Mail Address 7733 Harwell St

City, State & Zip Fort Worth, Texas 76108

Printed Michael A. Hunter Phone 817-246-4848 Date 10/30/2014

ADDITIONAL INFORMATION TO BE SUBMITTED WITH COMPLETED APPLICATION:
(FAILURE TO SUBMIT ALL THE REQUIRED MATERIALS WILL RESULT IN NON-
ACCEPTANCE OF THE APPLICATION. **BACKUP MATERIAL WILL BE ACCEPTED
UNTIL 9:00 A.M. THE MONDAY PRIOR TO THE MEETING. THERE WILL BE NO
EXCEPTIONS.)**

SITE PLAN: Must be drawn to scale, showing present and proposed construction
and locations of existing structures on adjacent lots.

All Sign Review Board cases must submit location and
elevation drawings, drawn to scale, in addition to the site
plan required.

APPLICATION FEES: Residential	\$388.00
All Other	\$688.00

Please be advised that the Board can only hear 16 new cases per month, therefore, applications
will be accepted on a first come, first served basis.

Please be advised that a request for reconsideration of any Board action must be filed within 10
days from the Board meeting/action.

If you need assistance completing this application (general inquires only) please contact:
Leane Heldenfels, (512)974-2202, leana.heldenfels@austintexas.gov
or Diana Ramirez, 974-2241, Diana.ramirez@austintexas.gov
505 Barton Springs Road, 1st floor, Development Assistance Center.

**NOTE: ALL VARIANCES EXPIRE 1 YEAR (12 MONTHS) FROM DATE OF
APPROVAL BY BOARD AS STATED IN SECTION 25-1-217 OF THE LAND
DEVELOPMENT CODE UNLESS BOARD DECISION STATES OTHERWISE.**

SIGN SPECIFICATIONS

4420 PolySign Multi-Panel Series
Double Posts and Pylon
Internally Illuminated
Double Sided Graphics



Support Posts:

Part Code: SP5208" x 8" Rectangular
Color: A46 Off White

Multi-Panel: (Side A & B Logo Panel)
MP2495-423.25" x 98"

Backgrd. Color: A27 Deep Grey@paque)

Illuminated Graphics:

Logo: LTBD (St. David's NAMC)
Size: 9"
Color: A01 White@translucent)

Copy: GaudyOldStyle BD BT
Size: 6 1/4" & 4 1/16@Small Capital)
Color: A01 White@translucent)

Multi-Panels: (Side A & B Message Panels)
MP1895-417.25" x 98"

1. Color: A46 Off White@paque)

MP3095-423.25" x 98"

Illuminated Graphics:

Arrow: A120
Size: 8"

Color: A69 American Red@translucent)


Copy: GaudyOldStyle BD BT

Copy: Comic Sans Bold

Size: 8"

Color: A69 American Red@translucent)

Note: Logo file available for Production Use.

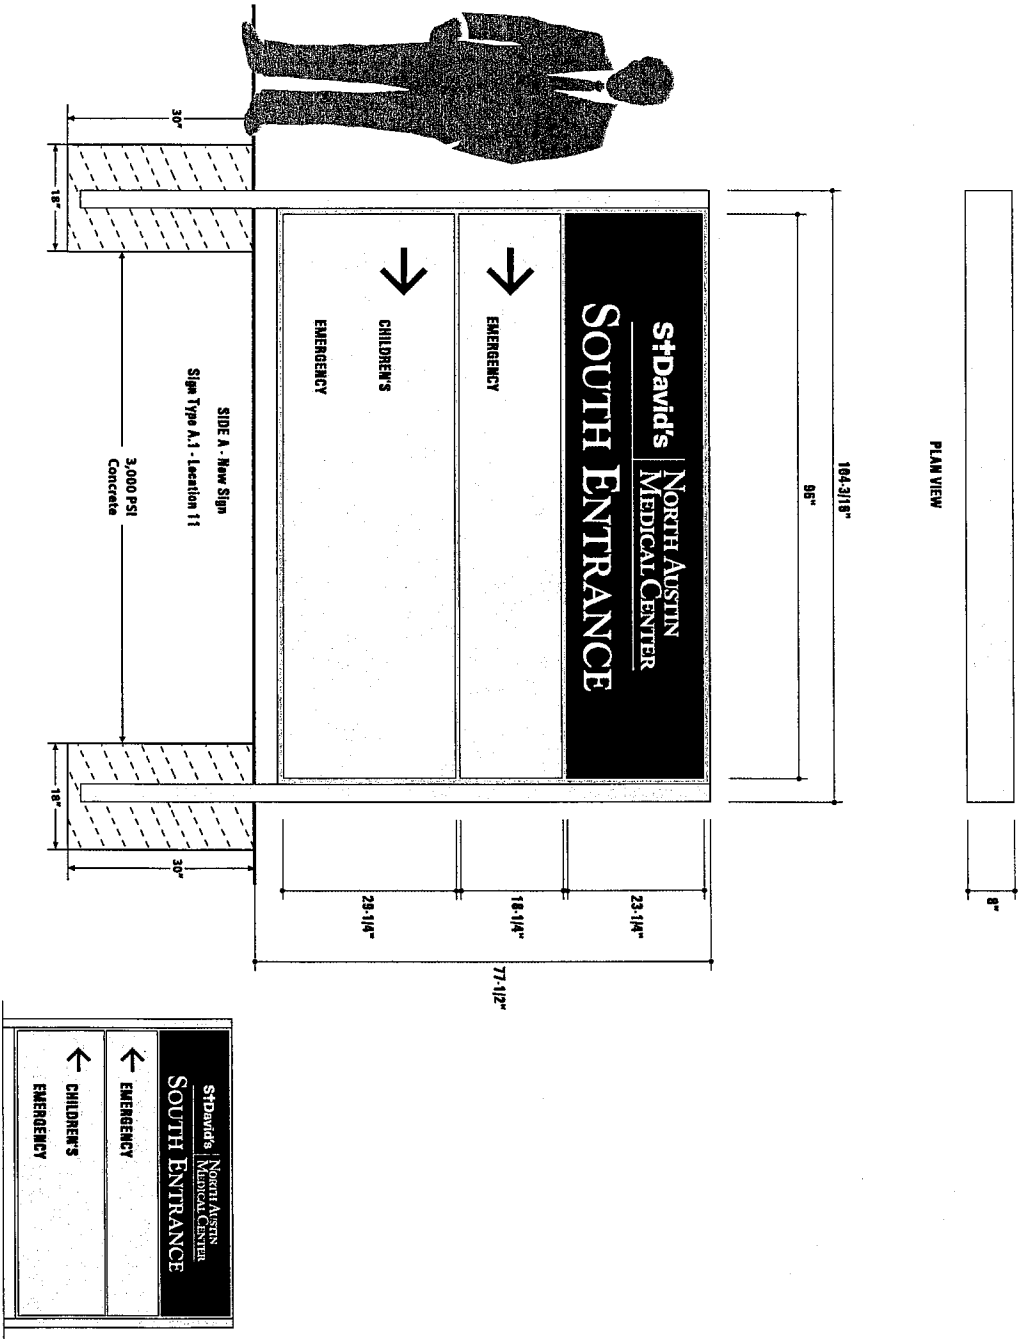

Colors depicted are a general representation of the color specified.
If color selection is critical, please request sample for approval.

APCO

apcosigns.com

Corporate Headquarters

388 Grant Street SE
Atlanta, GA 30312-2227
Ph: 404.688.9000, Fax: 404.577.3847
Email: sales@apcosigns.com

Project Reference:

Project: Children's EMERGENCY
- North Austin Med. Ctr.

Sales Rep: Diana Barcafar
CSR/PM:

Status:

Draft 19, May 2014 RHK
Revision 21, May 2014 RHK
Revision 13, June 2014 RHK
Revision 25, Aug. 2014 RHK

Date:

Drawn By:

Production Info:

Work Order #BD
Approved By:
Approved Date:
Customer approval is required prior to production.

Sign Type:


A.1
Location 11
4420 PolySign Series


Scale: 1/2" = 1'-0"

St. David's N. Austin Medical Center
12221 North Mopac Expwy., Austin, TX 78758

■ Removing Existing & Replacing with New
■ Street Frontage


H&M

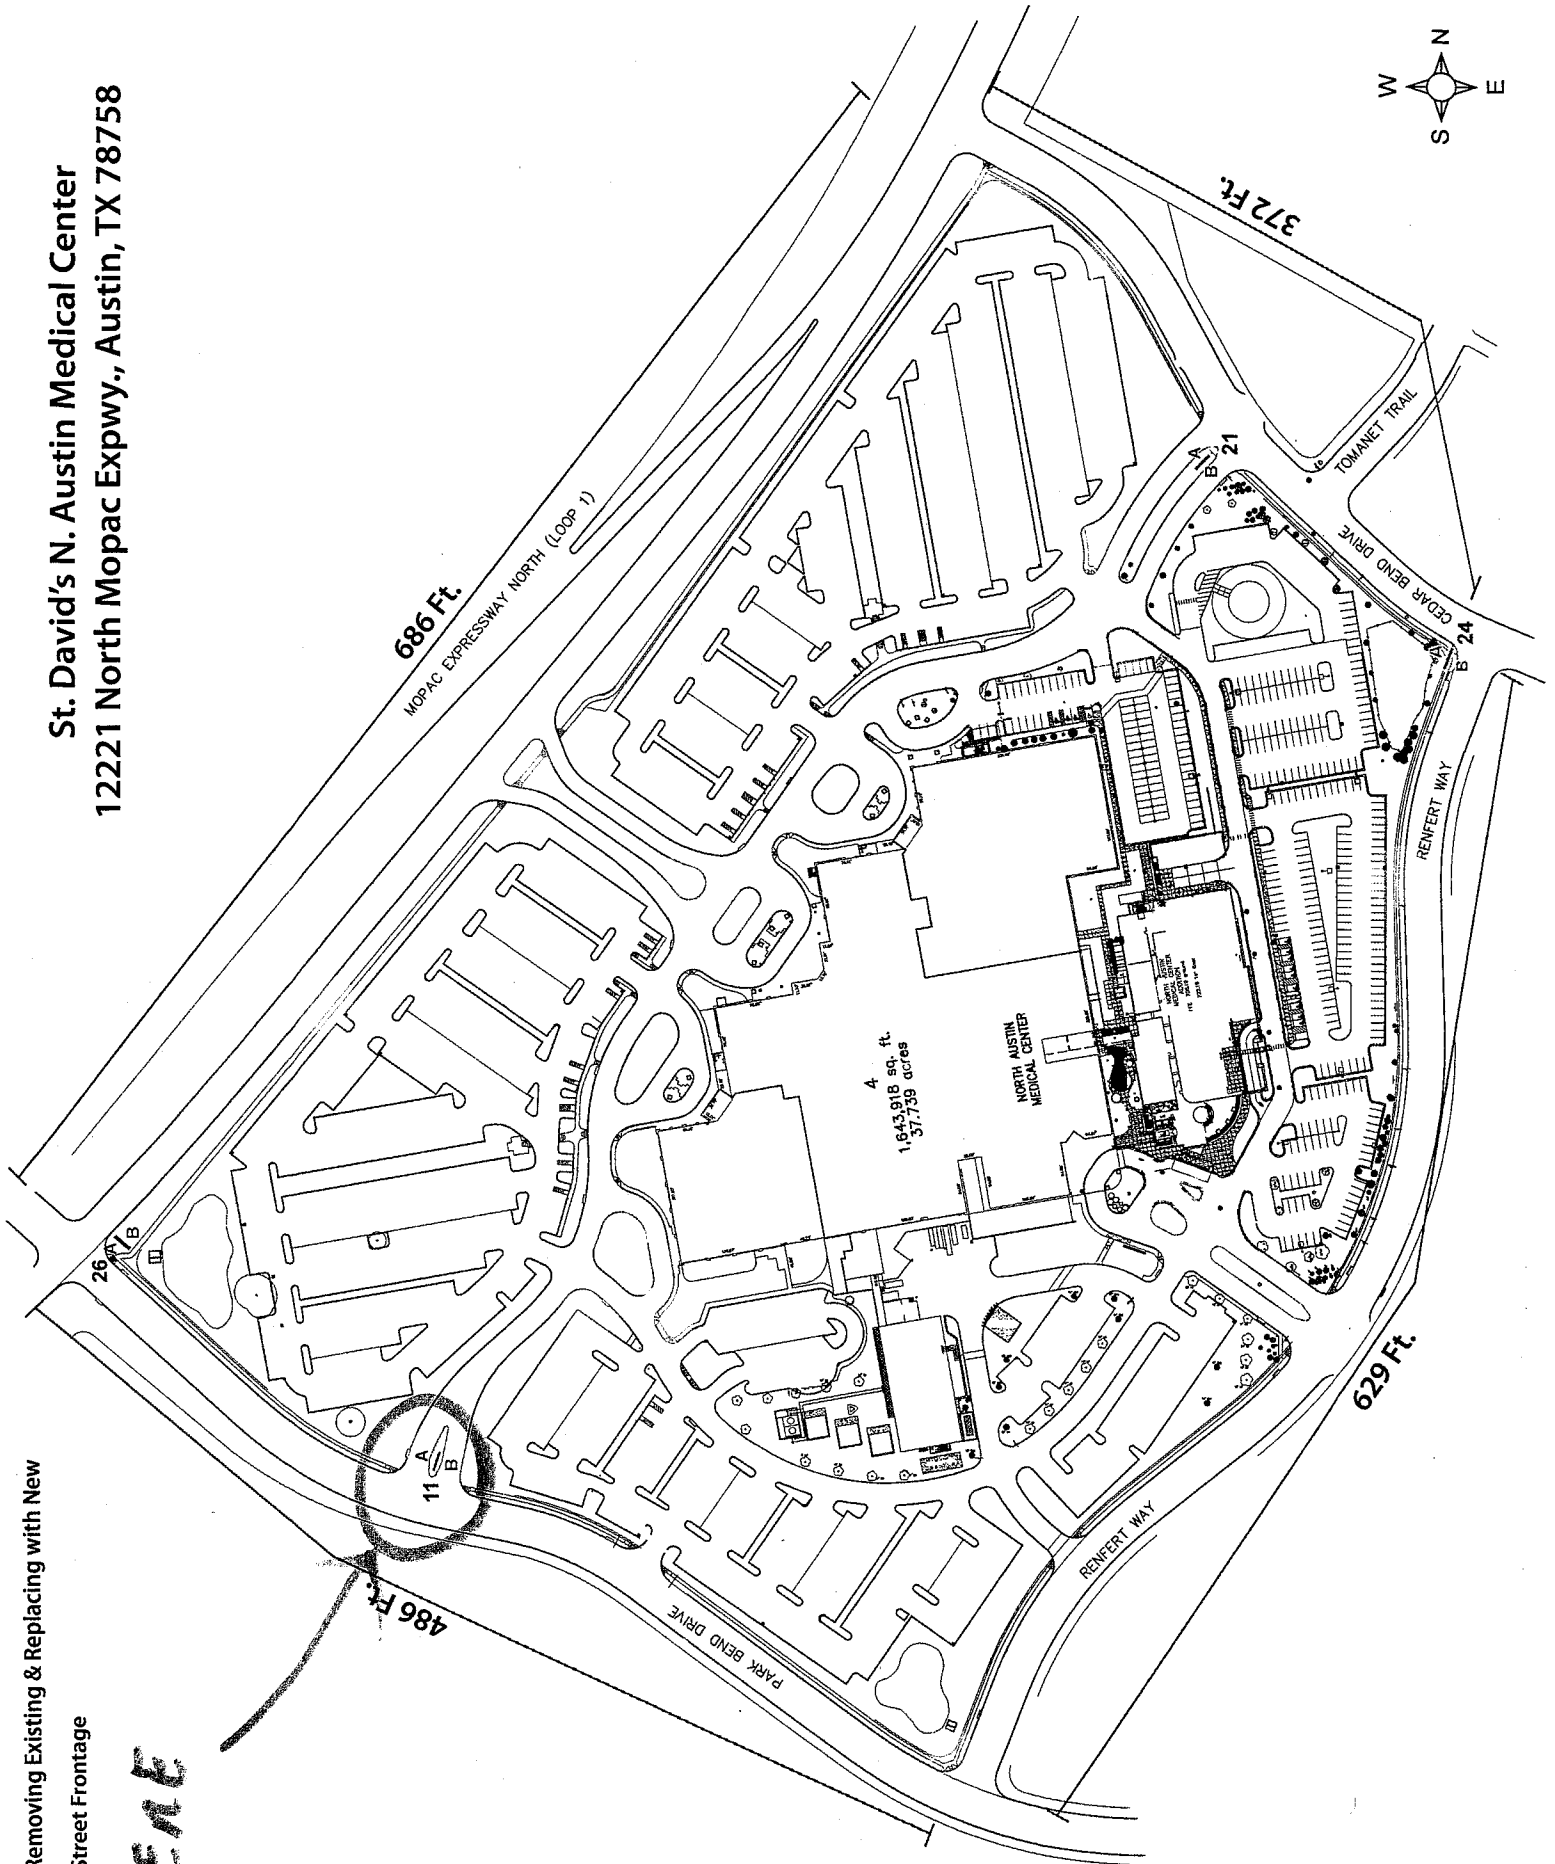

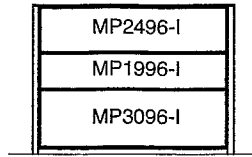

BACK VIEW


Scale: 1/8"=1'-0"

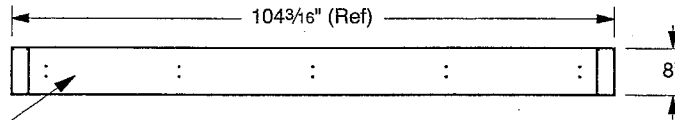

PLAN VIEW


Scale: 3/8"=1'-0"

Aluminum top plate mechanically secured with non-corrosive countersunk screws

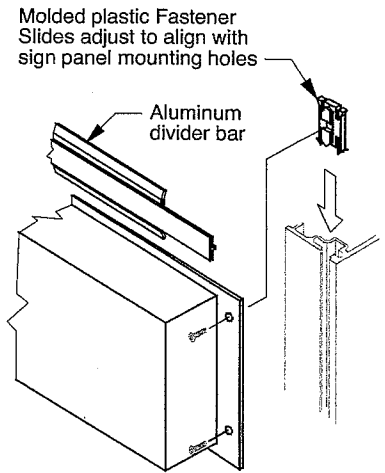


DETAIL '1': FASTENER SLIDE

Scale: None

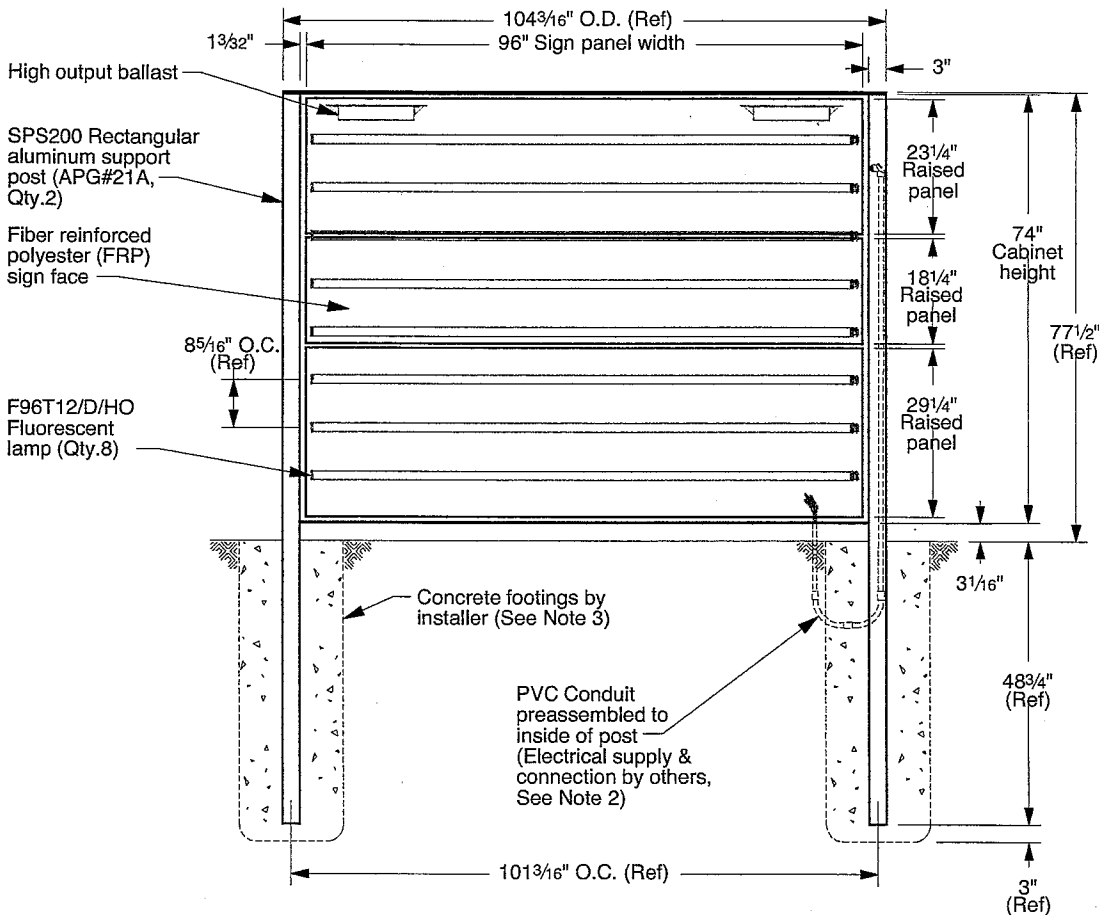

FRONT VIEW

Scale: 3/8"=1'-0"
(Side 'A' Shown)

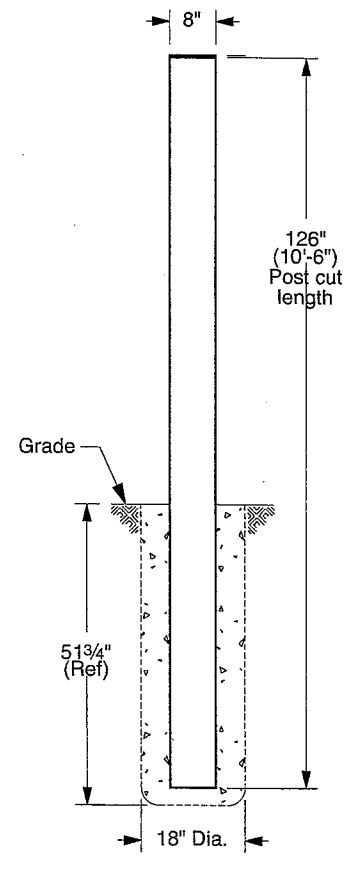

SIDE VIEW

Scale: 3/8"=1'-0"

NOTES:

1. Refer to presentation drawing and/or work order for colors, graphics specifications and sign panel sizes.
2. ___ V Electrical supply, conduit and associated fittings are by others. Installer to increase footing size as required to route conduit. Electrical connection performed by certified persons.
3. Footings are shown for reference only. Actual design and installation performed by certified persons based on local codes and geographic practices.
4. Lifting bolts are provided to assist with sign installation. Lifting brackets are accessible by removing post caps. Remove bolts after installation and replace post caps.

Location(s)

11

**APPROVAL
REQUIRED**

BY: _____

DATE: _____




Atlanta, Georgia USA • Phone: (404) 688-9000 • Web: www.apcosigns.com

All Design Rights Reserved


Customer: North Austin Medical Center
Project: Exterior Main Entrance
Location '11' - Elevation Views
Product: 4420 MultiPanel PolySign
Double Post Mount, Illuminated

Date: 10/01/14
Drawn: WWD
Scale: As Shown
Coord.: DTS
W.O.#: 437581


Sheet: 11.a

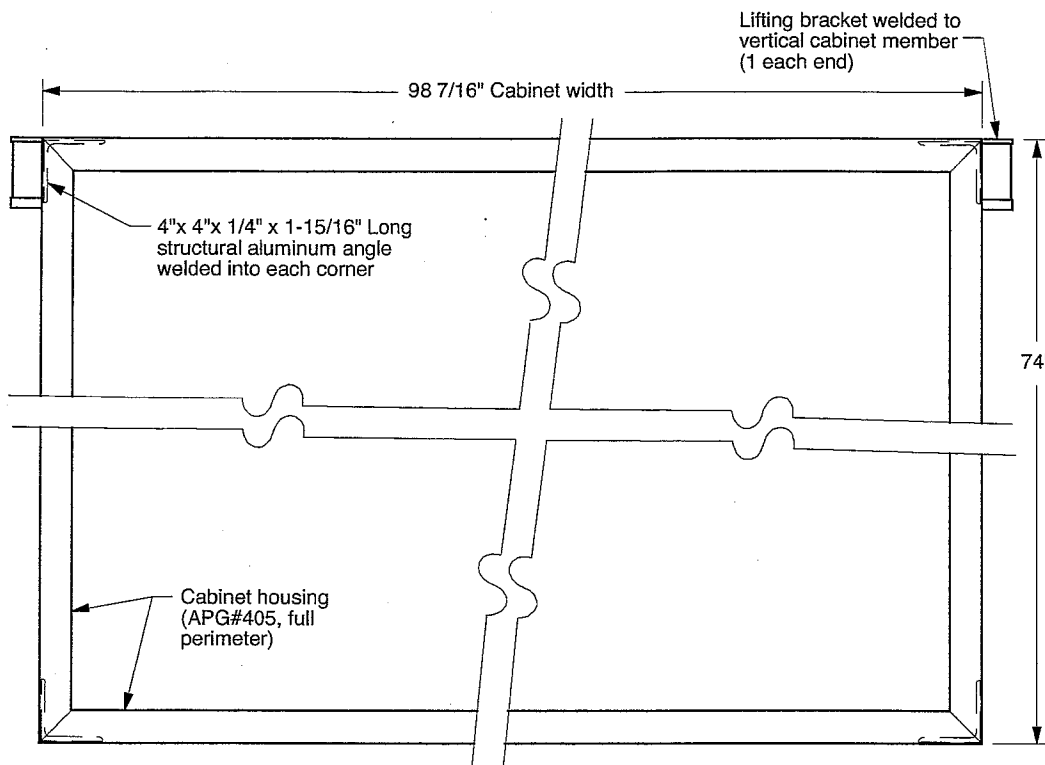

FRONT VIEW: SIGN CABINET
Scale: 1"=1'-0"

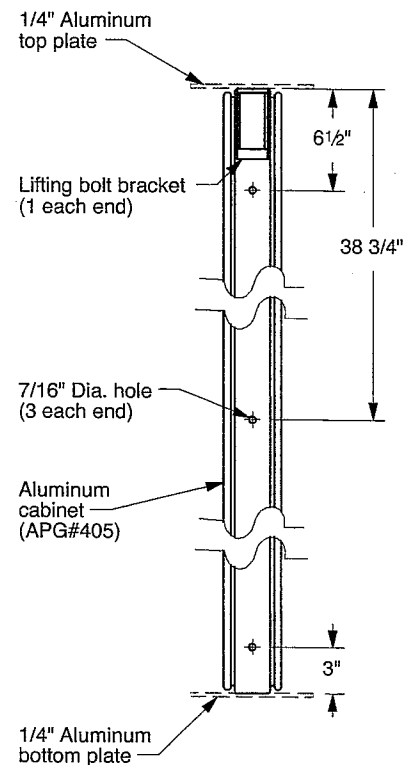

END VIEW
Scale: 1"=1'-0"

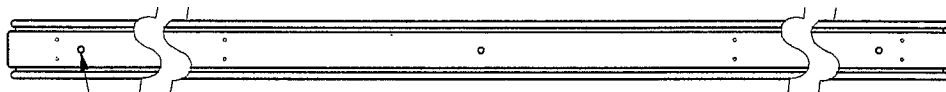

BOTTOM VIEW
Scale: 1"=1'-0"

NOTES:

1. Refer to presentation drawing and/or work order for colors, graphics specifications and sign panel sizes.

Location(s)
11

**APPROVAL
REQUIRED**

BY: _____
DATE: _____




Atlanta, Georgia USA • Phone: (404) 688-9000 • Web: www.apcosigns.com

All Design Rights Reserved

Customer: North Austin Medical Center
Project: Exterior Main Entrance
Location '11' - Cabinet Details
Product: 4420 MultiPanel PolySign
Double Post Mount, Illuminated

Date: 10/01/14
Drawn: WWD
Scale: As Shown
Coord.: DTS
W.O.#: 437581


Sheet: 11.b

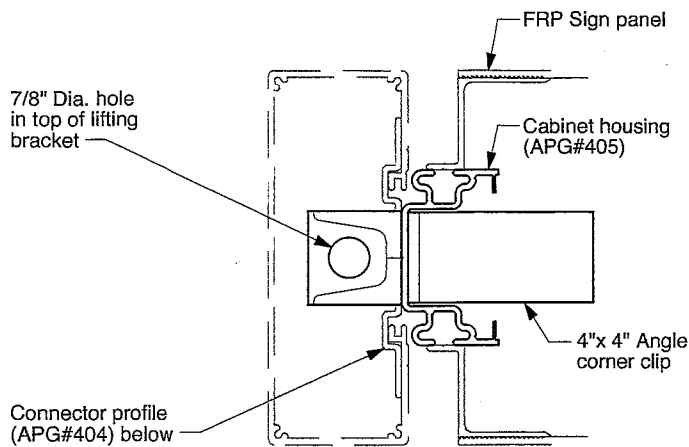


SECTION: "11.c1"
Scale: 1/4"=1"

Once sign is installed,
3/4" lifting bolt is
removed & post cap
is secured to post


1/4" Thick aluminum
post cap attached with
non-corrosive #10-24
flat head screws
(provided)

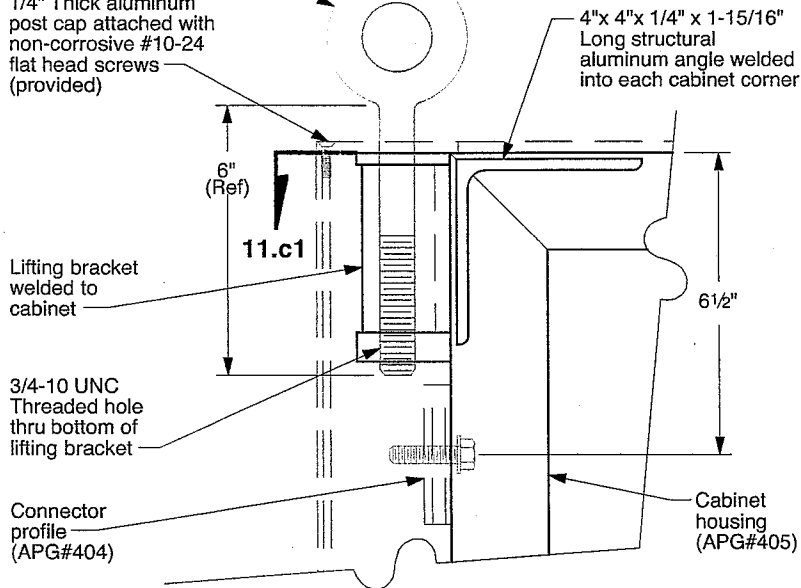


**FRONT SECTION VIEW @
LIFTING BRACKET**
Scale: 1/4"=1"

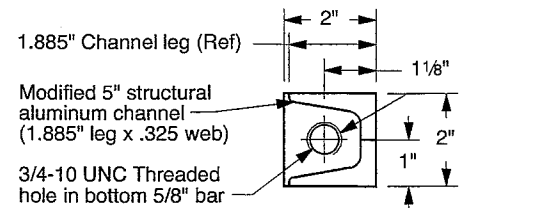


SECTION: "11.c2"
Scale: 1/4"=1"

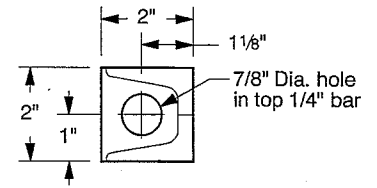

PLAN VIEW
Scale: 1/4"=1"

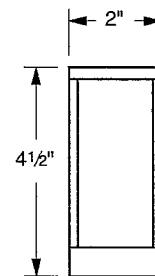

END VIEW
Scale: 1/4"=1"

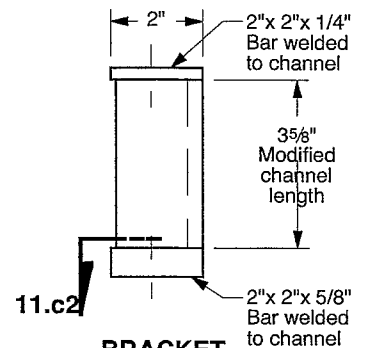

**BRACKET
FRONT VIEW**
Scale: 1/4"=1"

NOTES:

1. Lifting bolts are provided to assist with sign installation. Lifting brackets are accessible by removing post caps. In order to maintain structural integrity of the cabinet, use spreader beam and maintain a 90° angle between cabinet and both lifting bolts. Remove bolts after installation and replace post caps.

Location(s)
11

**APPROVAL
REQUIRED**

BY: _____

DATE: _____







Atlanta, Georgia USA • Phone: (404) 688-9000 • Web: www.apcosigns.com

All Design Rights Reserved

Customer: North Austin Medical Center
Project: Exterior Main Entrance
Location '11' - Lifting Bracket Details
Product: 4420 MultiPanel PolySign
Double Post Mount, Illuminated

Date: 10/01/14
Drawn: WWD
Scale: As Shown
Coord.: DTS
W.O.#: 437581

Sheet: 11.c

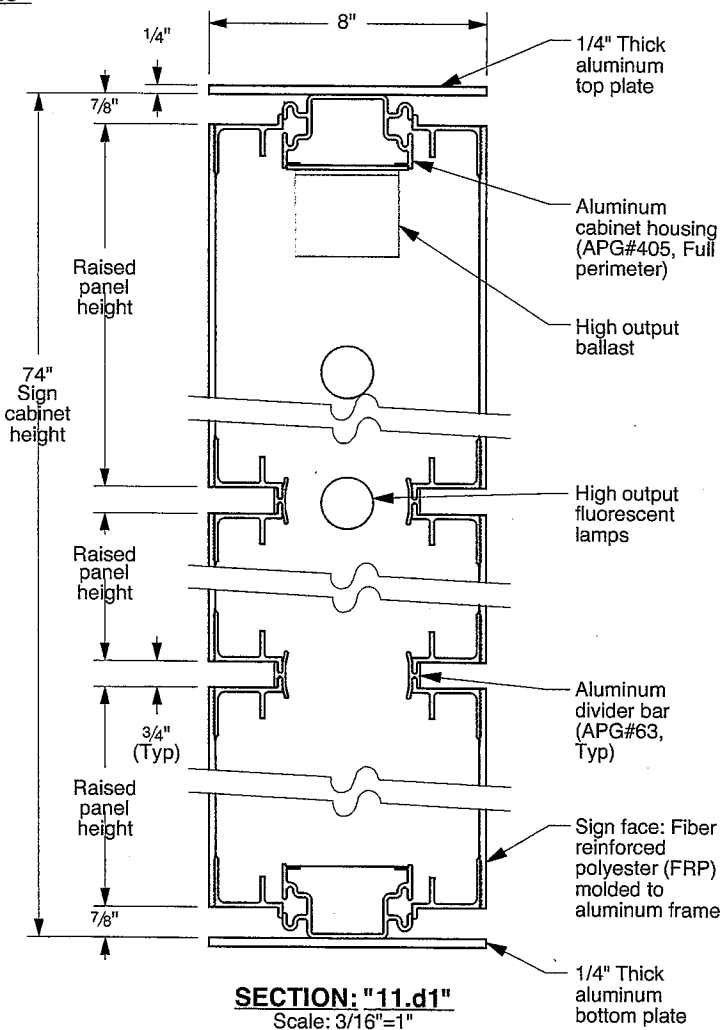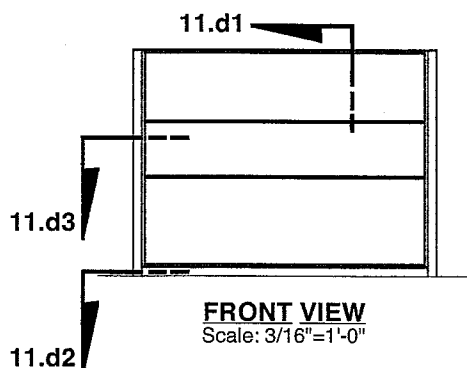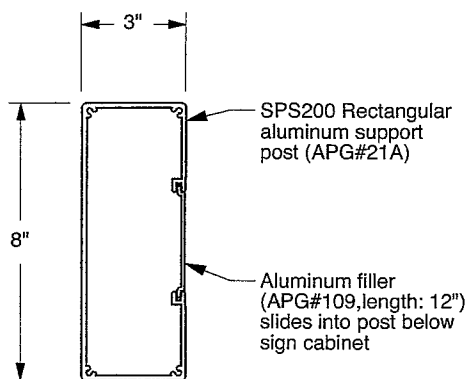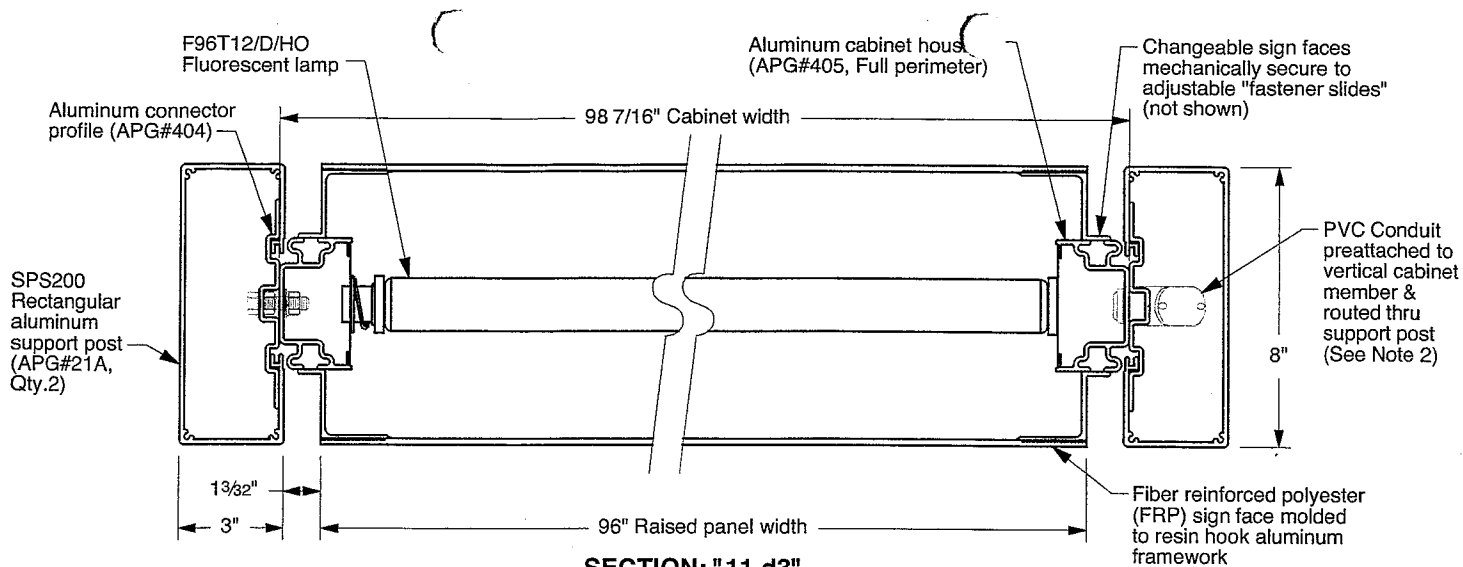

Location(s)
11

**APPROVAL
REQUIRED**

BY: _____
DATE: _____

NOTES:

1. Refer to presentation drawing and/or work order for colors, graphics specifications and sign panel sizes.
2. _____ V Electrical supply, conduit and associated fittings are by others. Installer to increase footing size as required to route conduit. Electrical connection performed by certified persons.




Atlanta, Georgia USA • Phone: (404) 688-9000 • Web: www.apcosigns.com

All Design Rights Reserved

Customer: North Austin Medical Center
Project: Exterior Main Entrance
Location '11' - Section Views
Product: 4420 MultiPanel PolySign
Double Post Mount, Illuminated

Date: 10/01/14
Drawn: WWD
Scale: As Shown
Coord.: DTS
W.O.#: 437581


Sheet: 11.d

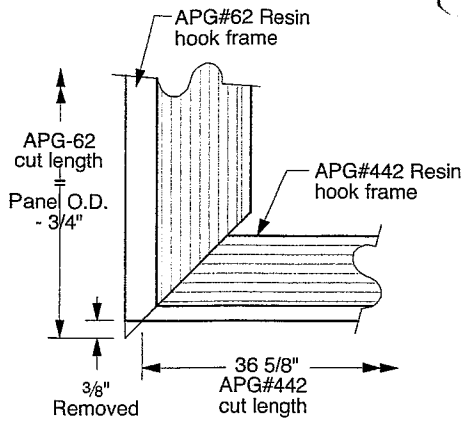

TYPICAL CORNER DETAIL

Scale: 1/4"=1"


APG#62 Resin hook frame (Left & right sides)

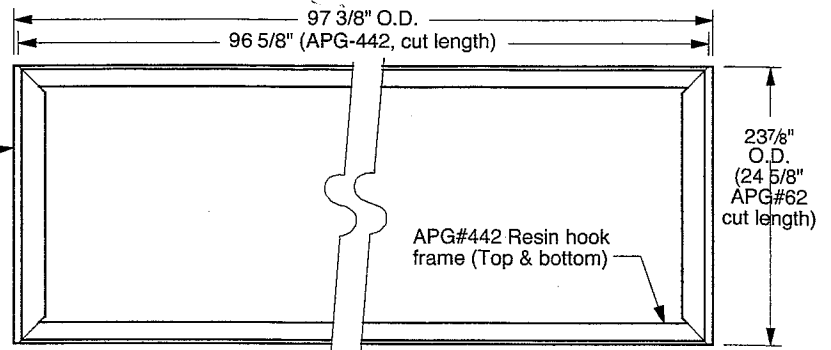

MP2496-I

Scale: 3/4"=1'-0"
(Qty.2, FRP not shown)


APG#62 Resin hook frame (Left & right sides)

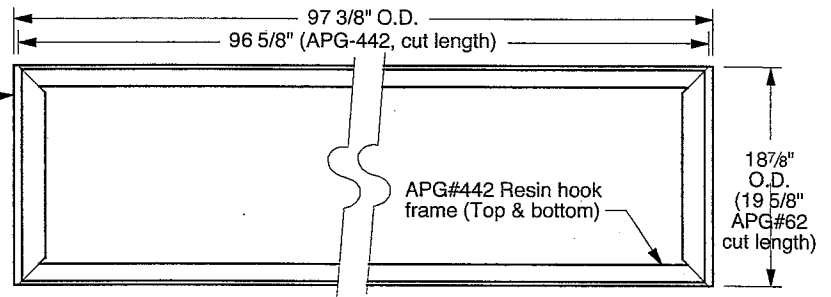

MP1996-I

Scale: 3/4"=1'-0"
(Qty.2, FRP not shown)

APG#62 Resin hook frame (Left & right sides)

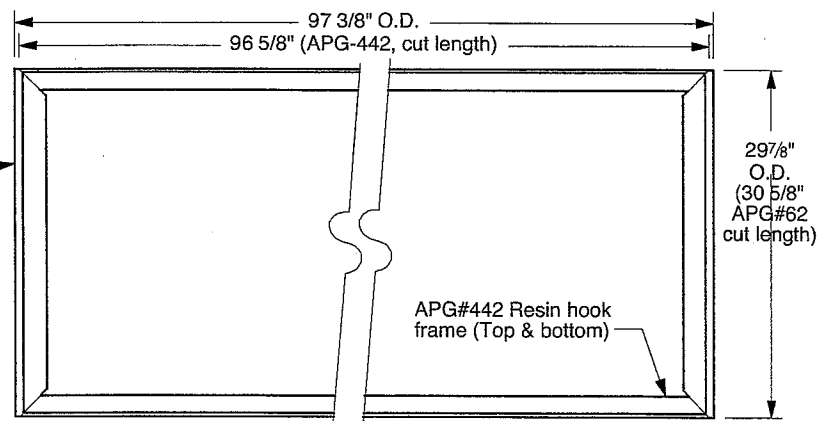

MP3096-I

Scale: 3/4"=1'-0"
(Qty.2, FRP not shown)

Location(s)

11

NOTES:

1. Refer to presentation drawing and/or work order for colors, graphics specifications and sign panel sizes.

APPROVAL REQUIRED

BY: _____

DATE: _____



apcosigns.com



Atlanta, Georgia USA • Phone: (404) 688-9000 • Web: www.apcosigns.com

All Design Rights Reserved

Customer: North Austin Medical Center
Project: Exterior Main Entrance
Location '11' - Section Views
Product: 4420 MultiPanel PolySign
Double Post Mount, Illuminated

Date: 10/01/14
Drawn: WWD
Scale: As Shown
Coord.: DTS
W.O.#: 437581

Sheet: 11.e

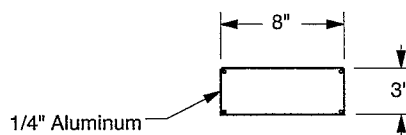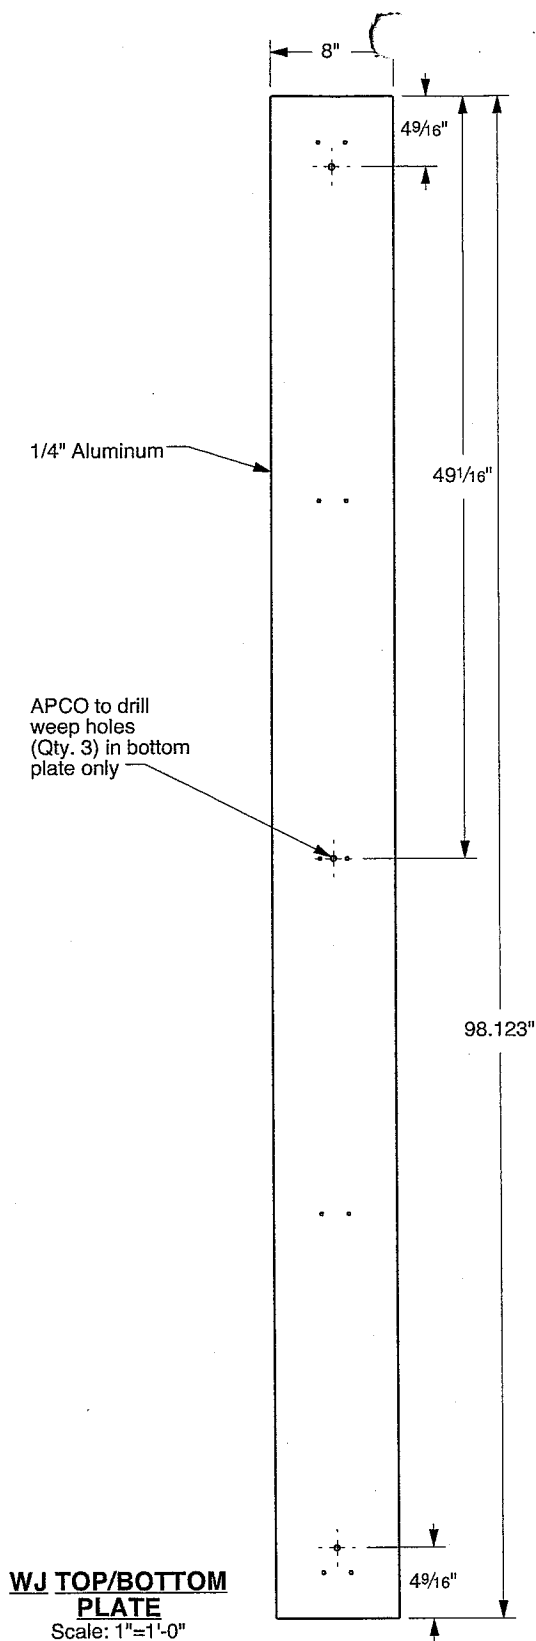

WJ POST CAP
Scale: 1"=1'-0"

Location(s)
11

NOTES:

1. Refer to presentation drawing and/or work order for colors, graphics specifications and sign panel sizes.

**APPROVAL
REQUIRED**

BY: _____

DATE: _____



apcosigns.com

Atlanta, Georgia USA • Phone: (404) 688-9000 • Web: www.apcosigns.com


All Design Rights Reserved

Customer: North Austin Medical Center
Project: Exterior Main Entrance
Location '11' - Water-Jet Parts
Product: 4420 MultiPanel PolySign
Double Post Mount, Illuminated

Date: 10/01/14
Drawn: WWD
Scale: As Shown
Coord.: DTS
W.O.#: 437581

Sheet: 11.f

Revisions	Date	Check
Wall increased from .125" to .140". Tolerance added & screwways changed from 90° to 60°	12/16/03	RCB
Redrawn in Graphite	12/06/06	WWD

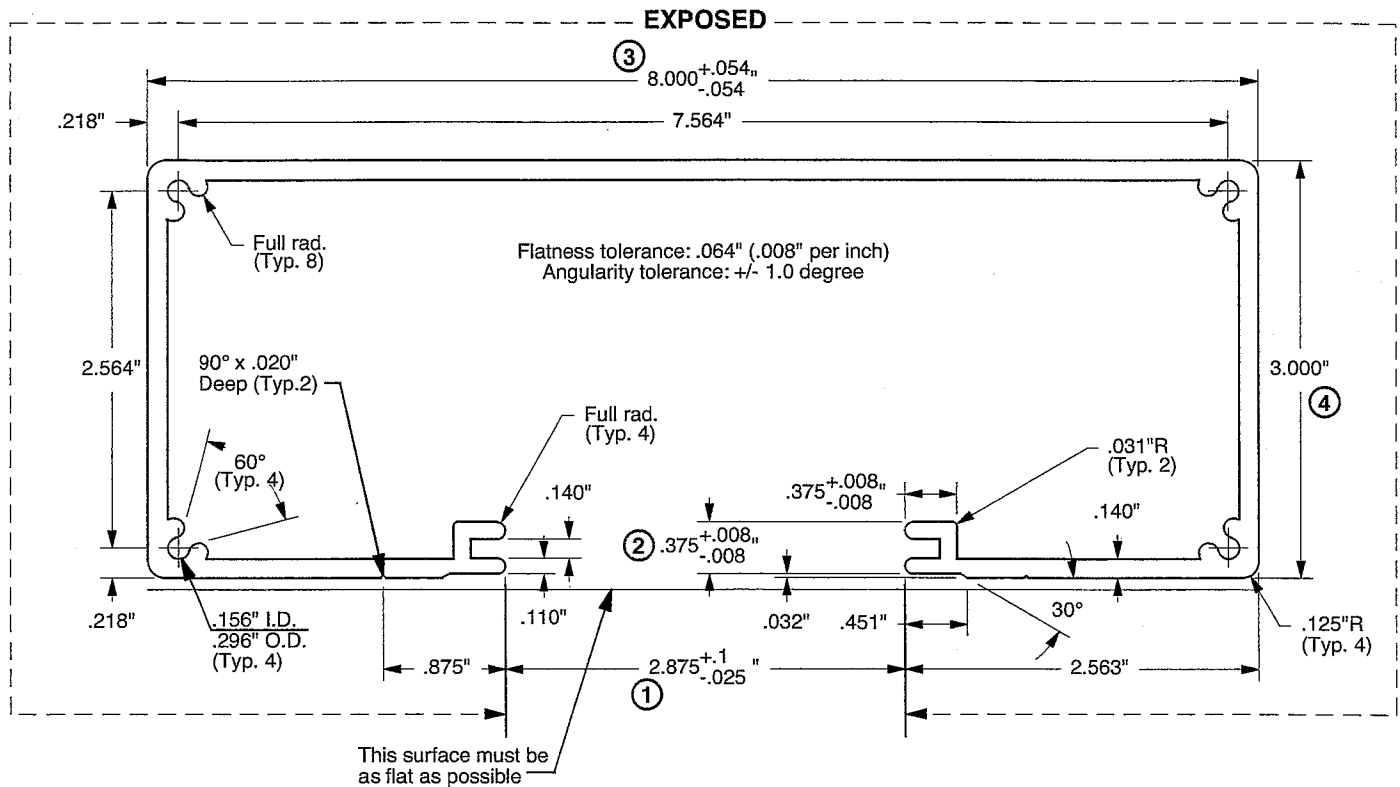

APG#21A

Wt. Per Area 1.2
Perimeter 40.242
Area 2.753
Weight 3.303
Centroid X -0
Centroid Y .769
Inertia IXX 4.422
Inertia IYY 25.196
Inertia IXY .001

Notes:

1. All design rights reserved.
2. All dimensions are in inches unless otherwise noted.
3. Numbered Bullets are Primary Inspected Areas.


APCO

Atlanta, Georgia USA • Phone: (404) 688-9000 • Web: www.apcosigns.com

Aluminum Assoc. Std. Tolerances Apply Unless Shown Otherwise		Solid () Semi-Hollow () Hollow I (X) Hollow II ()	Unspecified Corners 0.010"R 0.25 mm	Typ. Wall Unless Noted 0.140" 3.56 mm	Scale 3/4" = 1"	Date 12/09/03
Est. Area 2.753	Est. Weight 3.303 lbs./ft. 4.919 kg/m		Alloy 6063-T5	Finish Mill	Die Status Active	Order Code SPS200
Est. Perimeter 40.242" na	Ext. Int. USA Stock Length 24'-1"	Drawn JMM	Description Post 3" x 8" Rectangular			APG- 21A


LOC 11

SOUTH
ENTRANCE

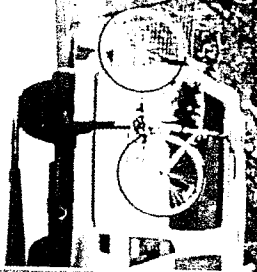

Removing Existing & Replacing with New
Street Frontage


St. David's N. Austin Medical Center
12221 North Mopac Expwy., Austin, TX 78758

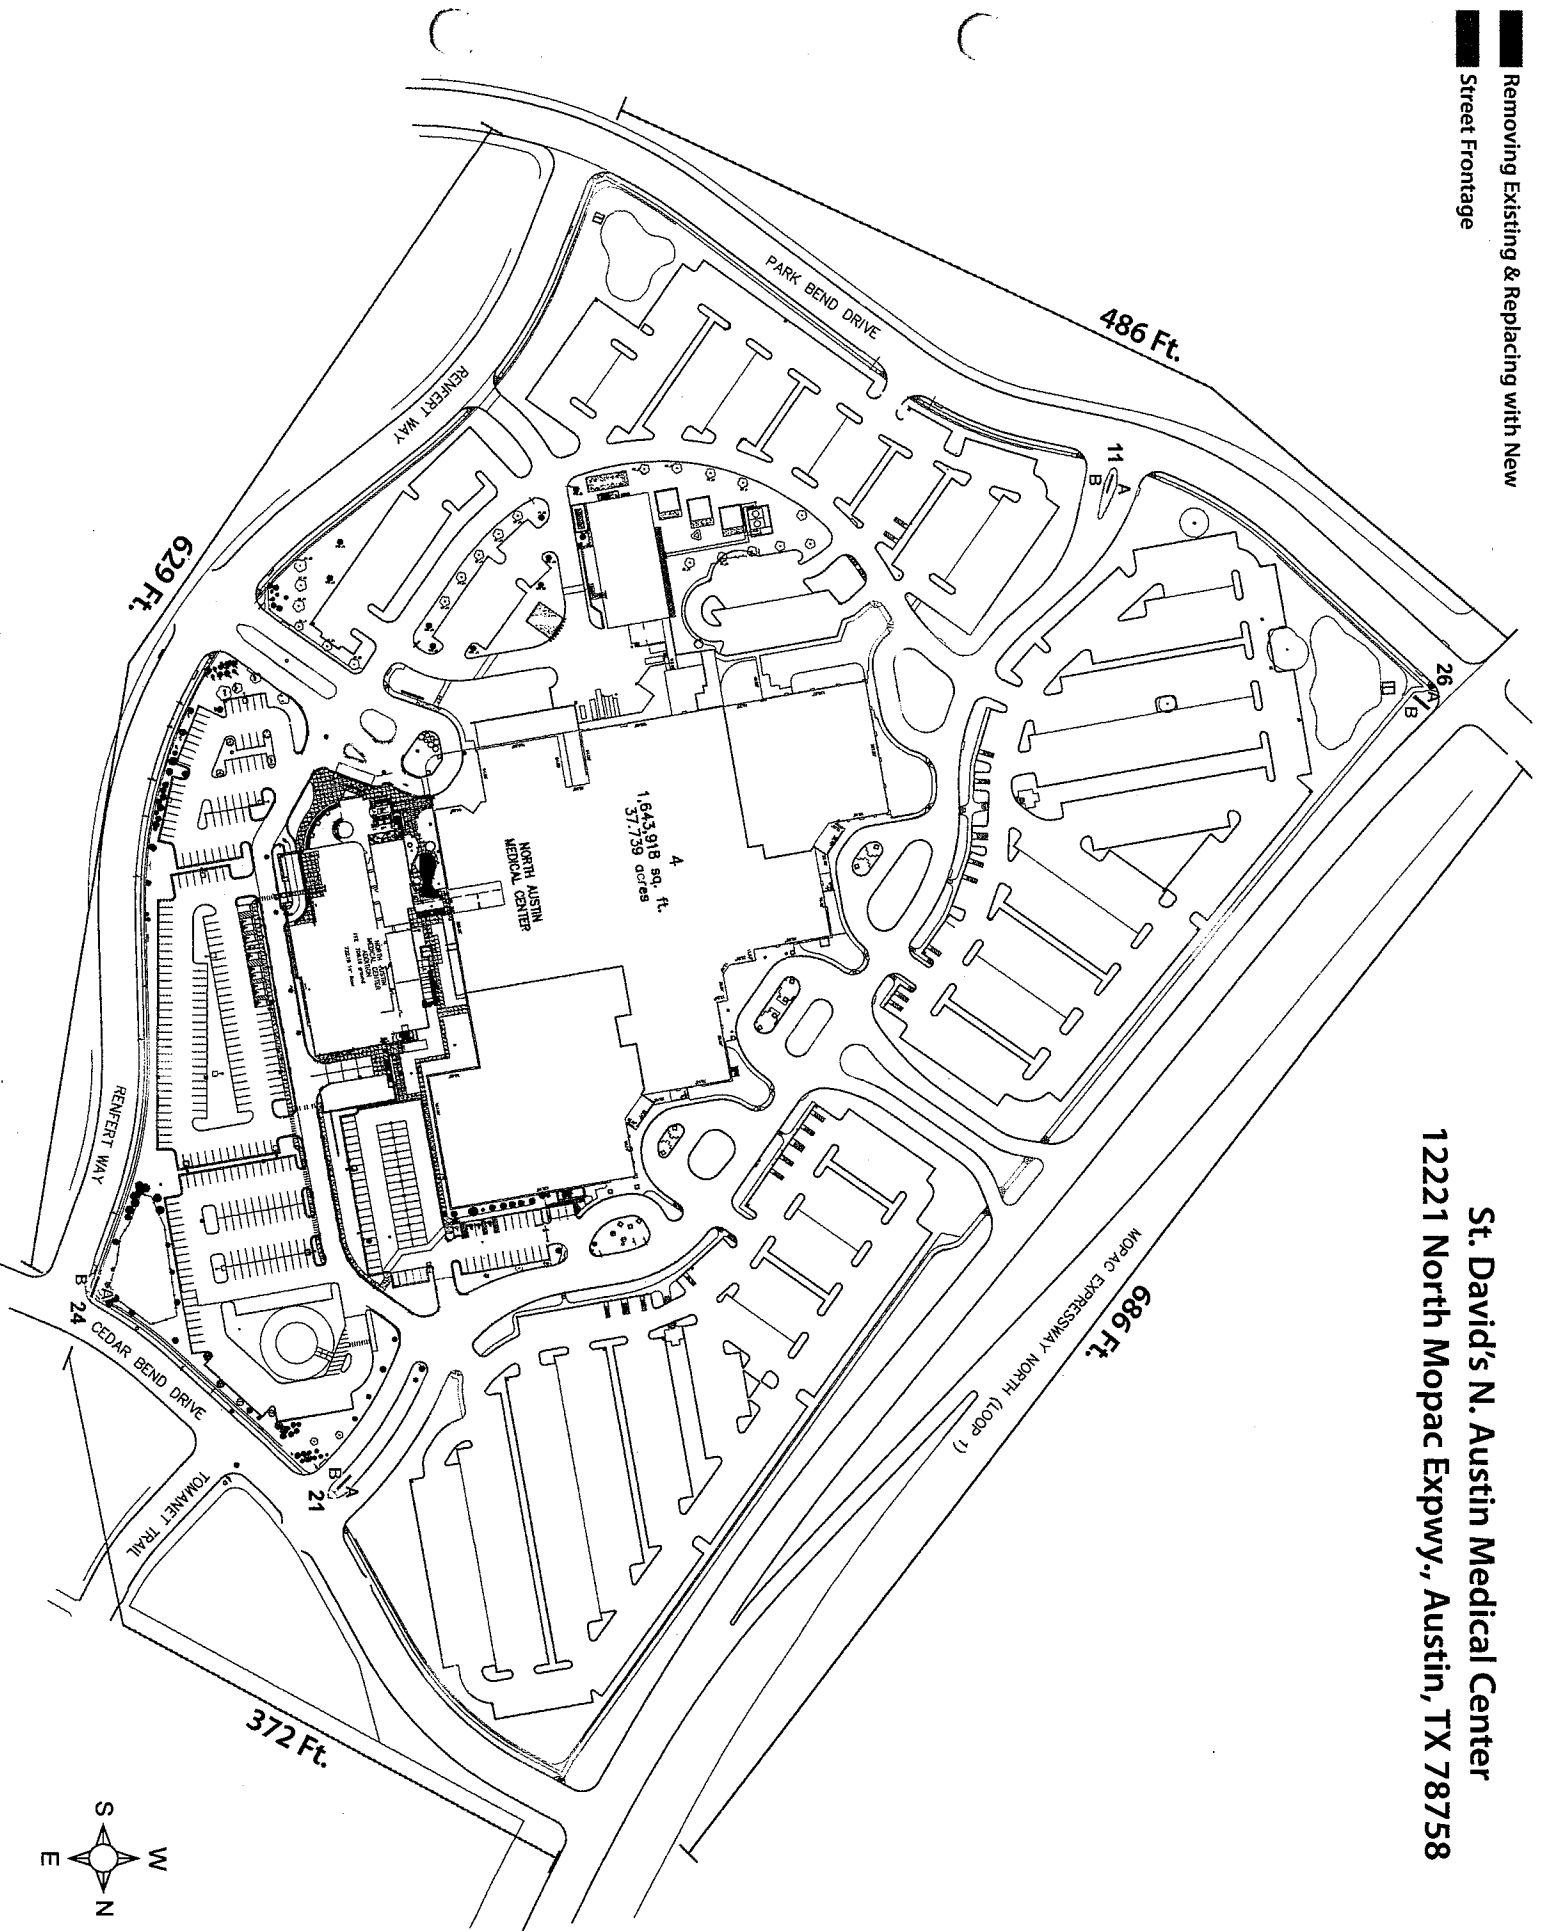



loc 11

SOUTH
ENTRANCE

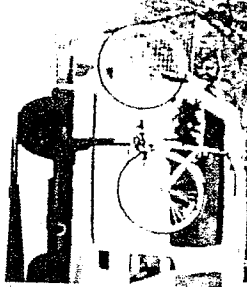

CASE # #21

CITY OF AUSTIN
APPLICATION TO SIGN REVIEW BOARD
SIGN VARIANCE

WARNING: Filing of this appeal stops all affected construction activity.

PLEASE: TYPE AND COMPLETE ALL REQUESTED INFORMATION.

STREET ADDRESS: 12221 N Mo-Pac Expressway Austin, TX 78758

LEGAL DESCRIPTION: Subdivision – 36.3670 A

Lot(s) 1 Block B Outlot Centrum Division The Resub of Blk B & E

I/We Michael A. Hunter on behalf of myself/ourselves as authorized agent for
St. David's North Austin Medical Center affirm that on October, 2014, hereby apply for a hearing before
the Sign Review Board for consideration:

ERECT – ATTACH – COMPLETE – REMODEL – MAINTAIN

Erect a new monument directional sign

in a _____ zoning district and located within the Scenic Roadway
Sign District.

If your variance request is for a reduction in setbacks or height limits, please contact Eben Kellogg with the Electric Utility at (512)322-6050 and send him a scan of your request to eben.kellogg@austinenenergy.com before filing your application with this office to discuss your request. The Electric Utility will recommend the board deny your request if it will result in an encroachment into an electric easement or a NESC violation.

NOTE: The Board must determine the existence of, sufficiency of and weight of evidence supporting the findings described below. In order to grant your request for a variance, the Board must first make one or more of the findings described under 1, 2, and 3 below; the Board must then make the finding described in item 4 below. If the Board cannot make the required findings, it cannot approve a sign variance.

Therefore, you must complete each of the applicable Findings Statements as part of your application. Failure to do so may result in your application being rejected as incomplete. Please attach any additional support documents.

VARIANCE FINDINGS: I contend that my entitlement to the requested variance is based on the following findings:

1. The variance is necessary because strict enforcement of the Article prohibits any reasonable opportunity to provide adequate signs on the site, considering the unique features of a site such as its dimensions, landscaping, or topography, because: The new proposed sign is of the
same type and design as previously approved signs for this property in Phase 1
approximately 2 years ago.

OR,

2. The granting of this variance will not have a substantially adverse impact upon neighboring properties, because: We are replacing an existing sign of the same nature in the
same location.

OR,

3. The granting of this variance will not substantially conflict with the stated purposes of this sign ordinance, because: The additional size is needed to convey directions to various
medical facilities within the campus

AND,

4. Granting a variance would not provide the applicant with a special privilege not enjoyed by others similarly situated or potentially similarly situated, because: This is an emergency med-
ical facility that needs to be able to convey directional information to those in need of
emergency medical care.

APPLICANT CERTIFICATE – I affirm that my statements contained in the complete application are true and correct to the best of my knowledge and belief.

Signed Michael A. Hunter Mail Address 7733 Harwell St

City, State & Zip Fort Worth, Texas 76108

Printed Michael A Hunter Phone 817-246-4848 Date 10/30/2014

OWNERS CERTIFICATE – I affirm that my statements contained in the complete application are true and correct to the best of my knowledge and belief.

Signed Michael A. Hunter Mail Address 7733 Harwell St

City, State & Zip Fort Worth, Texas 76108

Printed Michael A. Hunter Phone 817-246-4848 Date 10/30/2014

ADDITIONAL INFORMATION TO BE SUBMITTED WITH COMPLETED APPLICATION:
(FAILURE TO SUBMIT ALL THE REQUIRED MATERIALS WILL RESULT IN NON-
ACCEPTANCE OF THE APPLICATION. **BACKUP MATERIAL WILL BE ACCEPTED
UNTIL 9:00 A.M. THE MONDAY PRIOR TO THE MEETING. THERE WILL BE NO
EXCEPTIONS.)**

SITE PLAN: Must be drawn to scale, showing present and proposed construction
and locations of existing structures on adjacent lots.

All Sign Review Board cases must submit location and
elevation drawings, drawn to scale, in addition to the site
plan required.

APPLICATION FEES: Residential	\$388.00
All Other	\$688.00

Please be advised that the Board can only hear 16 new cases per month, therefore, applications
will be accepted on a first come, first served basis.

Please be advised that a request for reconsideration of any Board action must be filed within 10
days from the Board meeting/action.

If you need assistance completing this application (general inquires only) please contact:
Leane Heldenfels, (512)974-2202, leane.heldenfels@austintexas.gov
or Diana Ramirez, 974-2241, Diana.ramirez@austintexas.gov
505 Barton Springs Road, 1st floor, Development Assistance Center.

**NOTE: ALL VARIANCES EXPIRE 1 YEAR (12 MONTHS) FROM DATE OF
APPROVAL BY BOARD AS STATED IN SECTION 25-1-217 OF THE LAND
DEVELOPMENT CODE UNLESS BOARD DECISION STATES OTHERWISE.**

SIGN SPECIFICATIONS



4420 PolySign Multi-Panel Series
Double Posts and Pylon
Internally Illuminated
Double Sided Graphics

Support Posts:

Part Code: SP5208" x 8" Rectangular
Color: A46 Off White

Multi-Panel: (Side A & B Logo Panel)

MP2472-423.25" x 72"
Backgrd. Color: A27 Deep Grey (opaque)

Illuminated Graphics:

Logo: LTBD (St. David's NAMC)
Size: 9"
Color: A01 White (translucent)

Copy: GoudyOldStyle BD BT

Size: 6 1/4" & 4 1/16" (Small Copy)
Color: A01 White (translucent)

Multi-Panel: (Side A Message Panel)

MP1772-411.25" x 72"
a. Color: A46 Off White (opaque)

MP3672-435.25" x 72"

Backgrd. Color: A46 Off White (opaque)

Illuminated Graphics:

Arrow: A120
Size: 6"

Color: DayLite (translucent)
Color: A69 American Red (translucent)

Copy: GoudyOldStyle BD BT

Size: 5"
Color: DayLite (translucent)
Color: A69 American Red (translucent)

Multi-Panel: (Side B Message Panel)

MP1772-411.25" x 72"
Backgrd. Color: A46 Off White (opaque)

MP3672-435.25" x 72"

Backgrd. Color: A46 Off White (opaque)

Illuminated Graphics:

Arrow: A120
Size: 6"




Color: DayLite (translucent)
Color: A69 American Red (translucent)

Copy: GoudyOldStyle BD BT

Size: 5"
Copy: Comic Sans Bold

Color: DayLite (translucent)
Color: A69 American Red (translucent)

Note: Logo file available for Production Use.

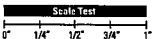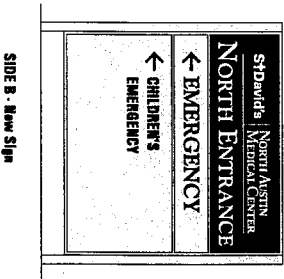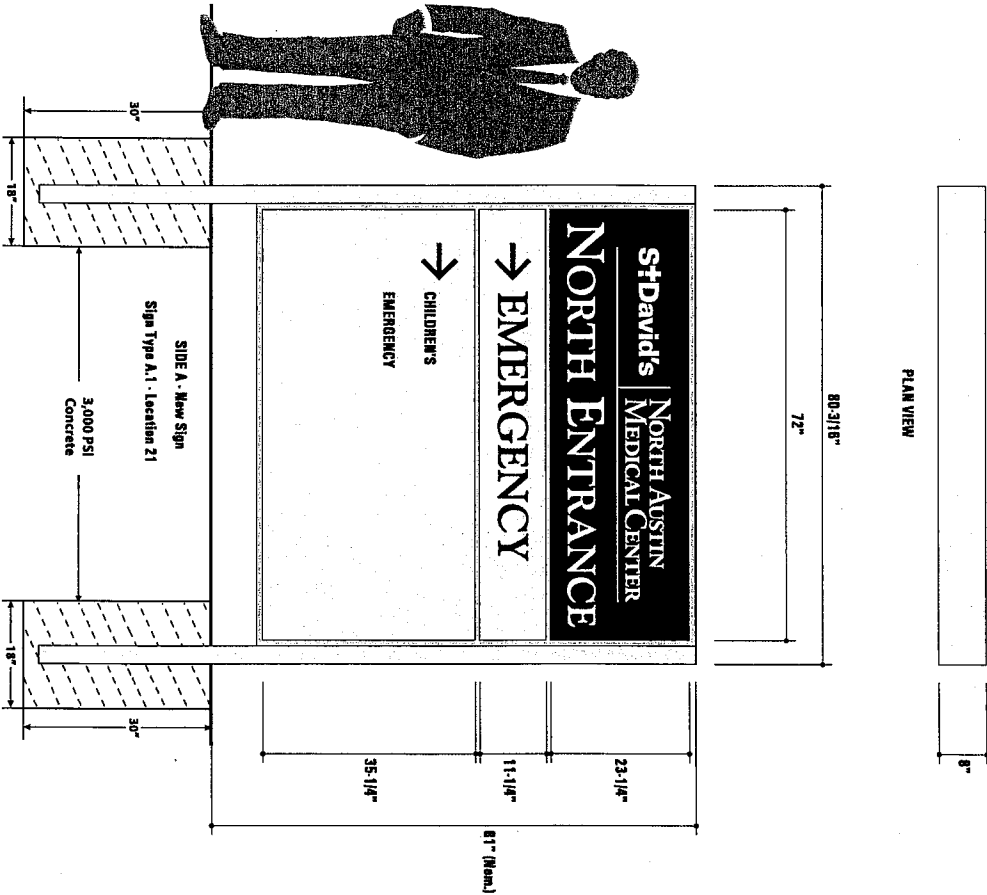

Colors depicted are a general representation of the color specified.
If color selection is critical, please request sample for approval.

APCO

apcosigns.com

Corporate Headquarters

388 Grant Street SE
Atlanta, GA 30312-2227
Ph: 404 688 9000, Fax: 404 577 3847
Email: sales@apcosigns.com

Project Reference:

Project: Children's EMERGENCY
- North Austin Med. Ctr.

Sales Rep: Diana Barcafara

CSR/PM:

Status:

Draft
Revision
Revision

Date:

19, May 2014
21, May 2014
13, June 2014
25, Aug. 2014

Drawn By:

RHK
RHK
RHK
RHK

Production Info:

Work Order #BD
Approved By:
Approved Date:

Customer approval is required prior to production.


Sign Type:

A.1
Location 21
4420 PolySign Series


Scale: 1/2" = 1' - 0"

■ Removing Existing & Replacing with New
■ Street Frontage


St. David's N. Austin Medical Center
12221 North Mopac Expwy., Austin, TX 78758

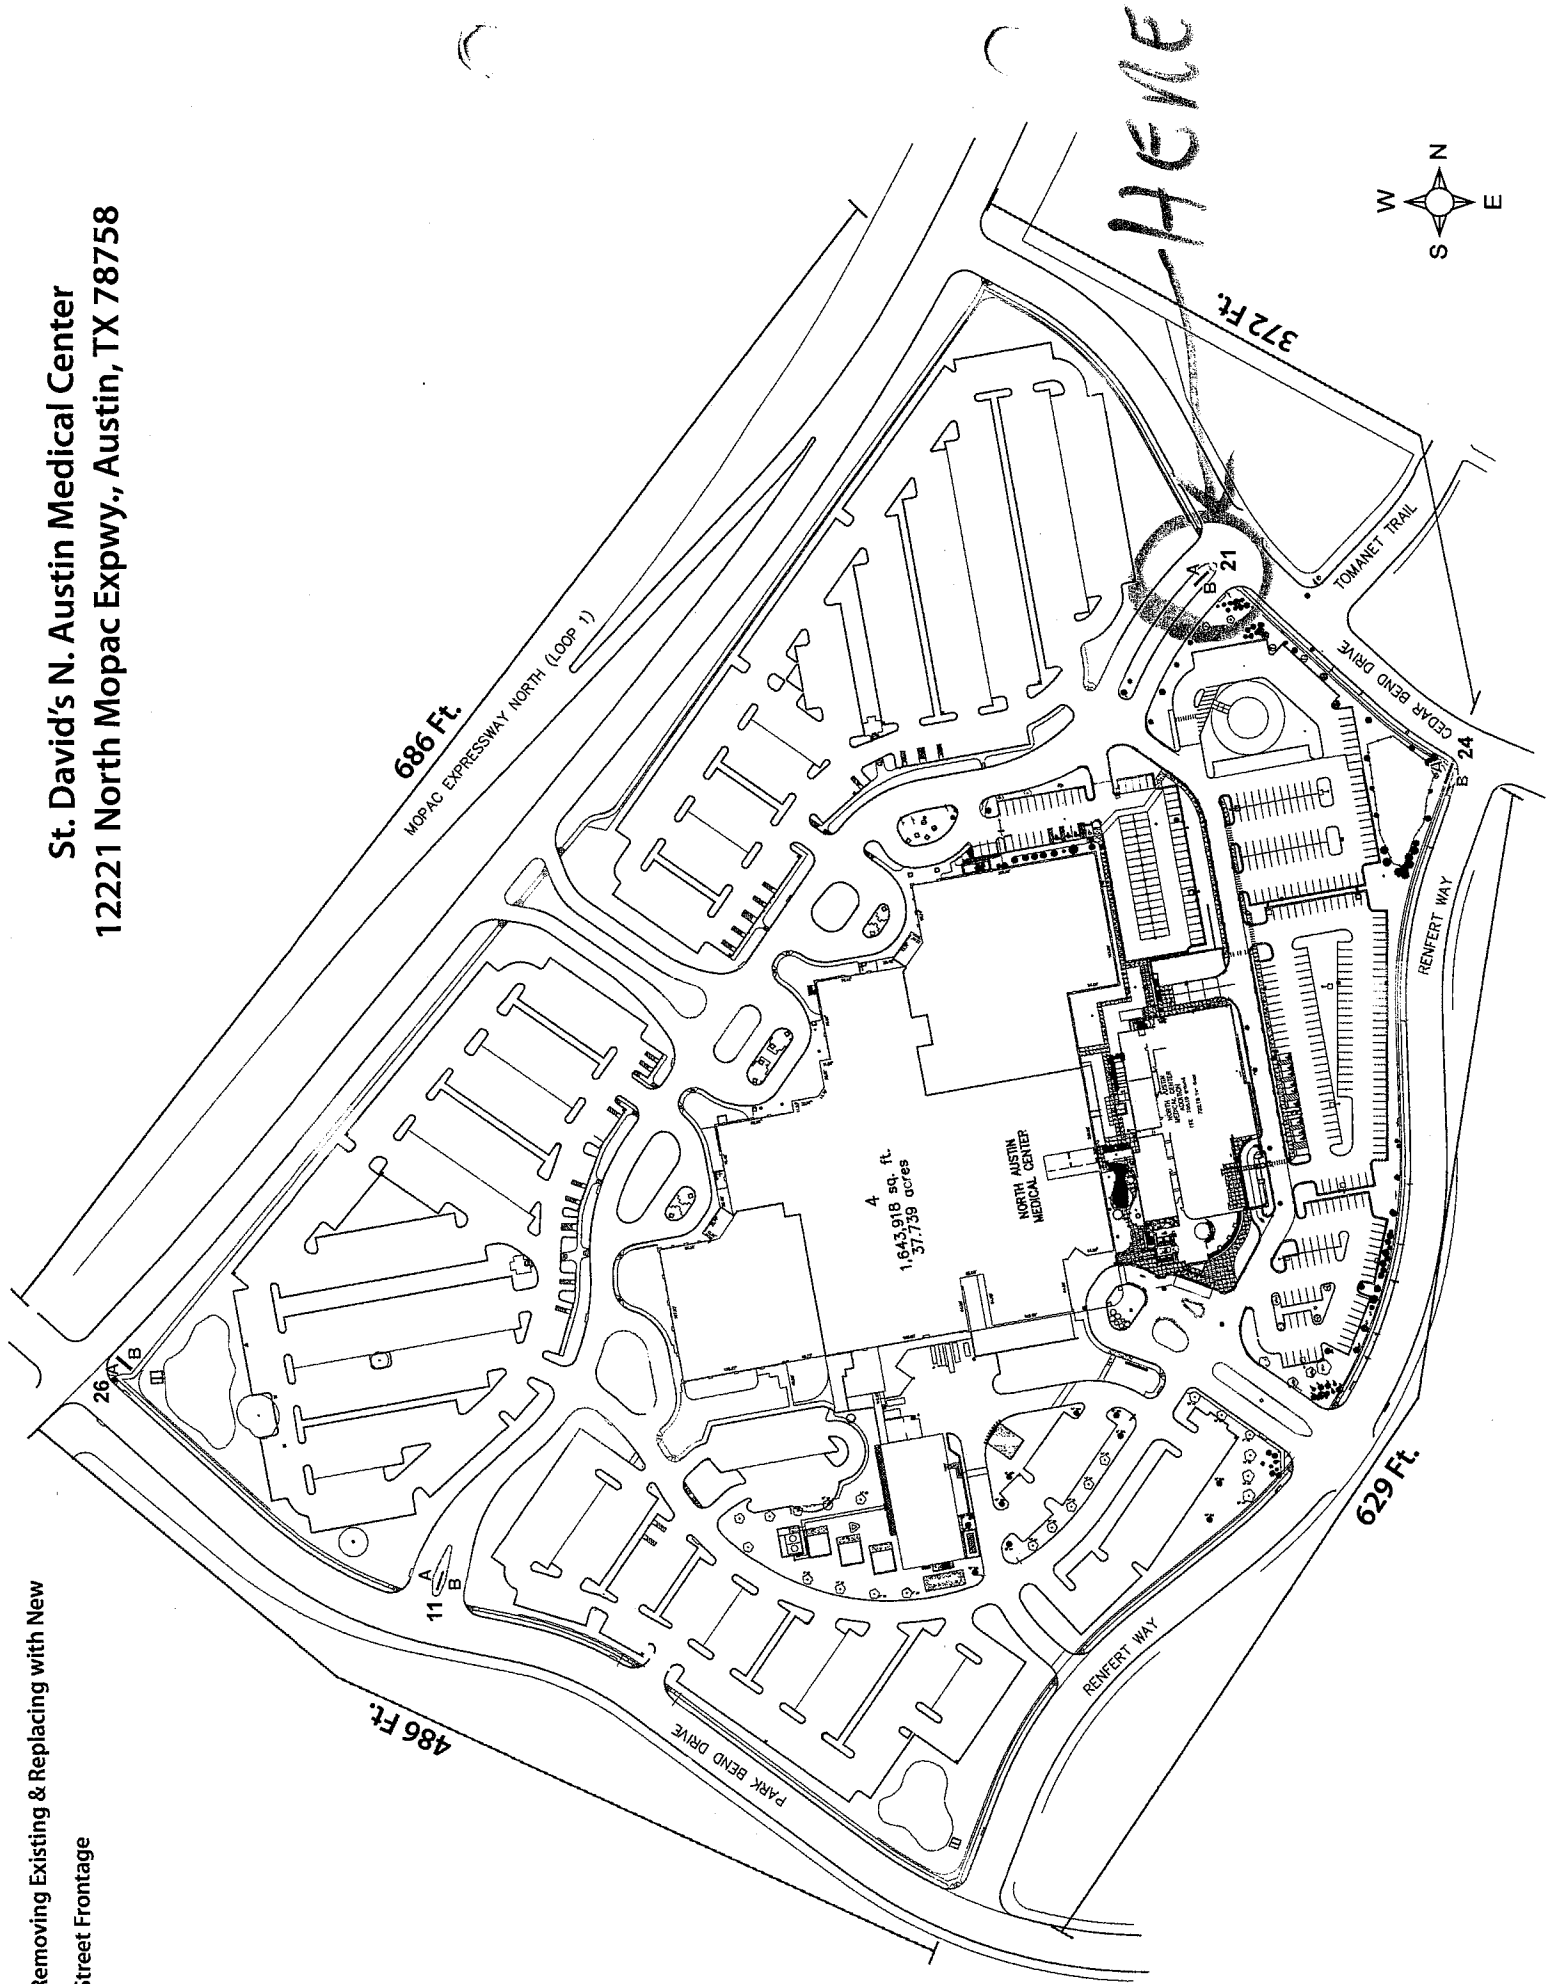

PROPOSED 516 W LOCATIONS

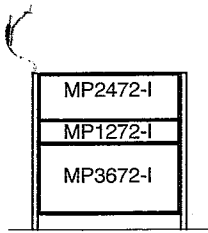


BACK VIEW
Scale: 1/8"=1'-0"

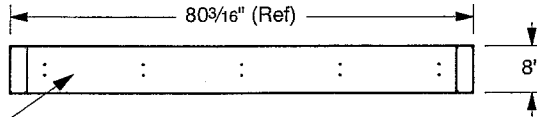


PLAN VIEW
Scale: 3/8"=1'-0"


Aluminum top plate mechanically secured with non-corrosive countersunk screws

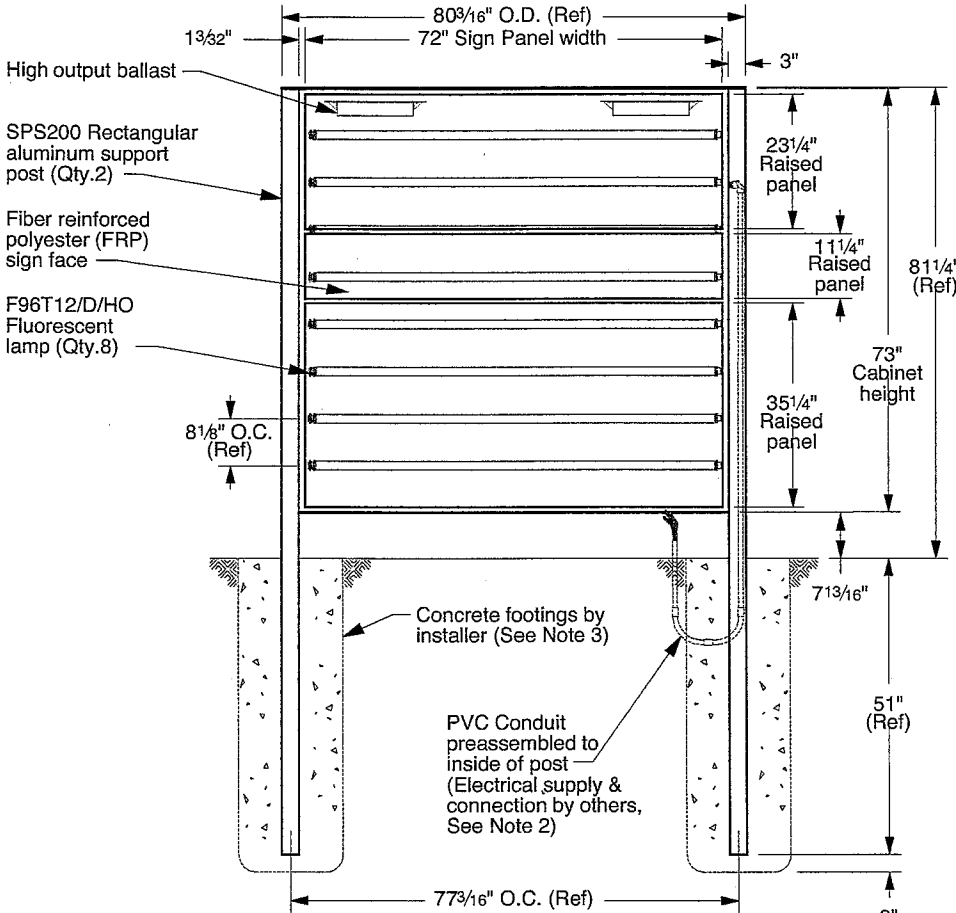

FRONT VIEW
Scale: 3/8"=1'-0"
(Side 'A' Shown)

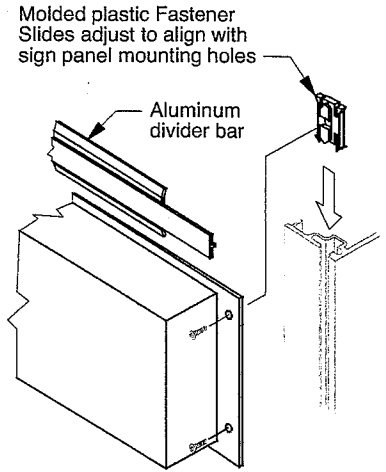

DETAIL '1': FASTENER SLIDE
Scale: None

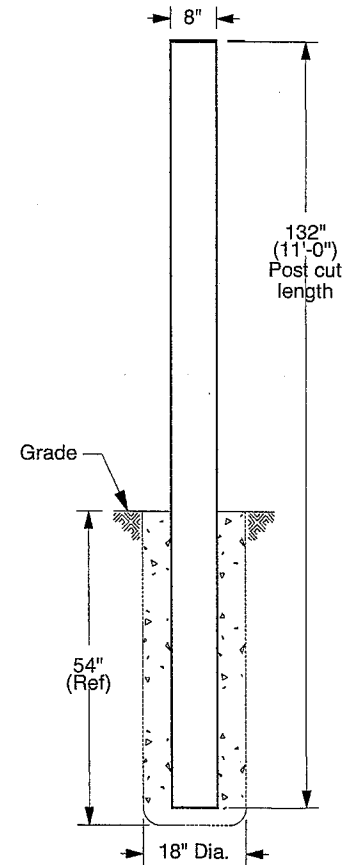

SIDE VIEW
Scale: 3/8"=1'-0"

NOTES:

1. Refer to presentation drawing and/or work order for colors, graphics specifications and sign panel sizes.
2. ____ V Electrical supply, conduit and associated fittings are by others. Installer to increase footing size as required to route conduit. Electrical connection performed by certified persons.
3. Footings are shown for reference only. Actual design and installation performed by certified persons based on local codes and geographic practices.
4. Lifting bolts are provided to assist with sign installation. Lifting brackets are accessible by removing post caps. Remove bolts after installation and replace post caps.

Location(s)
21

APPROVAL REQUIRED

BY: _____
DATE: _____




Atlanta, Georgia USA • Phone: (404) 688-9000 • Web: www.apcosigns.com

All Design Rights Reserved

Customer: North Austin Medical Center
Project: Exterior Main Entrance
Location '21' - Elevation Views
Product: 4420 MultiPanel PolySign
Double Post Mount, Illuminated


Date: 10/01/14
Drawn: WWD
Scale: As Shown
Coord.: DTS
W.O.#: 437581

Sheet: 21.a

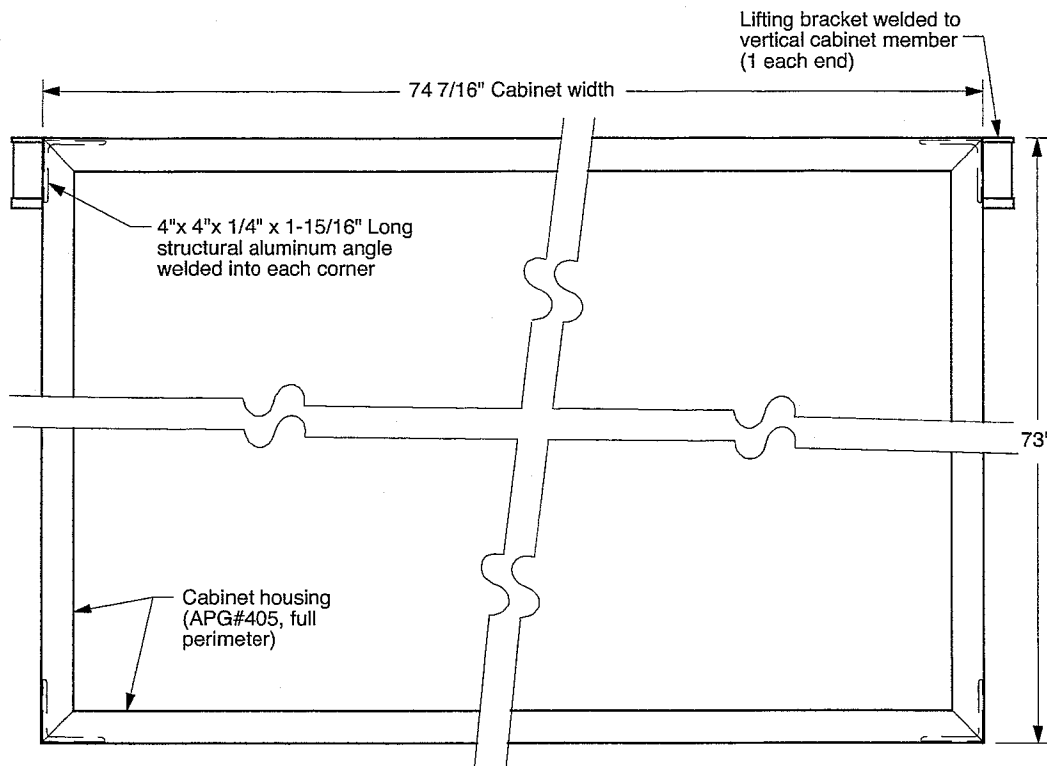


FRONT VIEW: SIGN CABINET

Scale: 1"=1'-0"

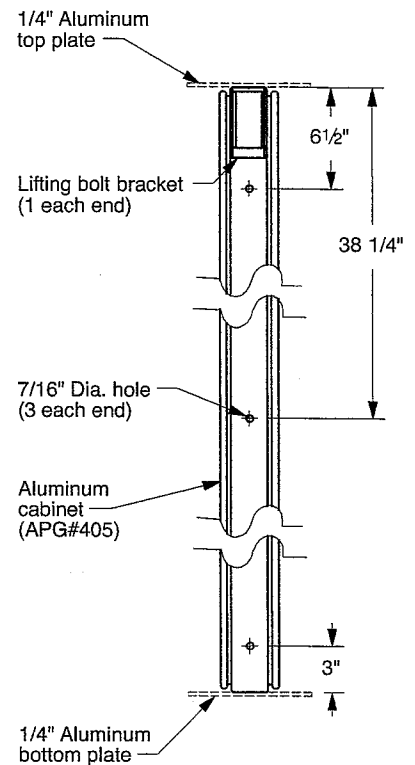

END VIEW

Scale: 1"=1'-0"

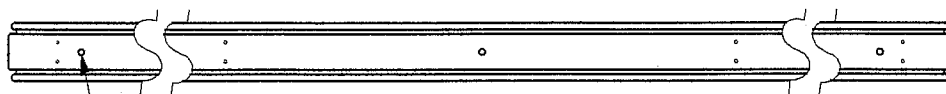

BOTTOM VIEW

Scale: 1"=1'-0"

NOTES:

1. Refer to presentation drawing and/or work order for colors, graphics specifications and sign panel sizes.

Location(s)
21

**APPROVAL
REQUIRED**

BY: _____
DATE: _____




Atlanta, Georgia USA • Phone: (404) 688-9000 • Web: www.apcosigns.com

All Design Rights Reserved

Customer: North Austin Medical Center
Project: Exterior Main Entrance
Location '21' - Cabinet Details
Product: 4420 MultiPanel PolySign
Double Post Mount, Illuminated

Date: 10/01/14
Drawn: WWD
Scale: As Shown
Coord.: DTS
W.O.#: 437581

Sheet: 21.b

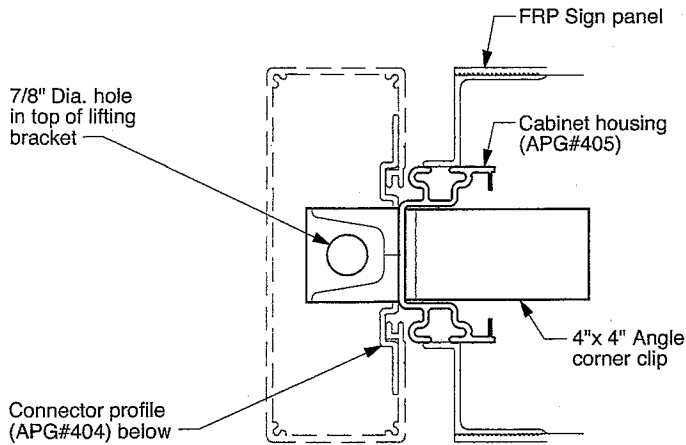

SECTION: "21.c1"
Scale: 1/4"=1"

Once sign is installed,
3/4" lifting bolt is
removed & post cap
is secured to post

1/4" Thick aluminum
post cap attached with
non-corrosive #10-24
flat head screws
(provided)

4" x 4" x 1/4" x 1-15/16"
Long structural
aluminum angle welded
into each cabinet corner


Lifting bracket
welded to
cabinet

3/4-10 UNC
Threaded hole
thru bottom of
lifting bracket


Connector
profile
(APG#404)

Cabinet
housing
(APG#405)


**FRONT SECTION VIEW @
LIFTING BRACKET**
Scale: 1/4"=1"

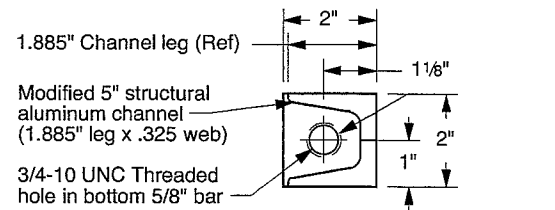


SECTION: "21.c2"
Scale: 1/4"=1"

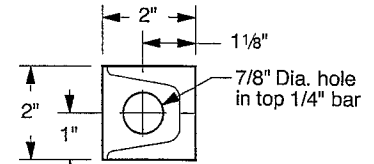

PLAN VIEW
Scale: 1/4"=1"

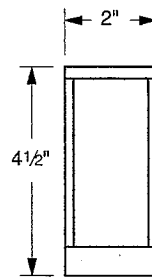

END VIEW
Scale: 1/4"=1"

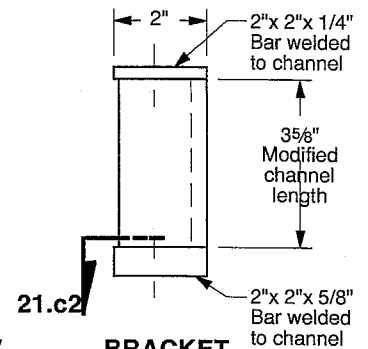

**BRACKET
FRONT VIEW**
Scale: 1/4"=1"

NOTES:

1. Lifting bolts are provided to assist with sign installation. Lifting brackets are accessible by removing post caps. In order to maintain structural integrity of the cabinet, use spreader beam and maintain a 90° angle between cabinet and both lifting bolts. Remove bolts after installation and replace post caps.

Location(s)
21

**APPROVAL
REQUIRED**

BY: _____
DATE: _____







Atlanta, Georgia USA • Phone: (404) 688-9000 • Web: www.apcosigns.com

All Design Rights Reserved

Customer: North Austin Medical Center
Project: Exterior Main Entrance
Location '21' - Lifting Bracket Details
Product: 4420 MultiPanel PolySign
Double Post Mount, Illuminated

Date: 10/01/14
Drawn: WWD
Scale: As Shown
Coord.: DTS
W.O.#: 437581

Sheet: 21.c

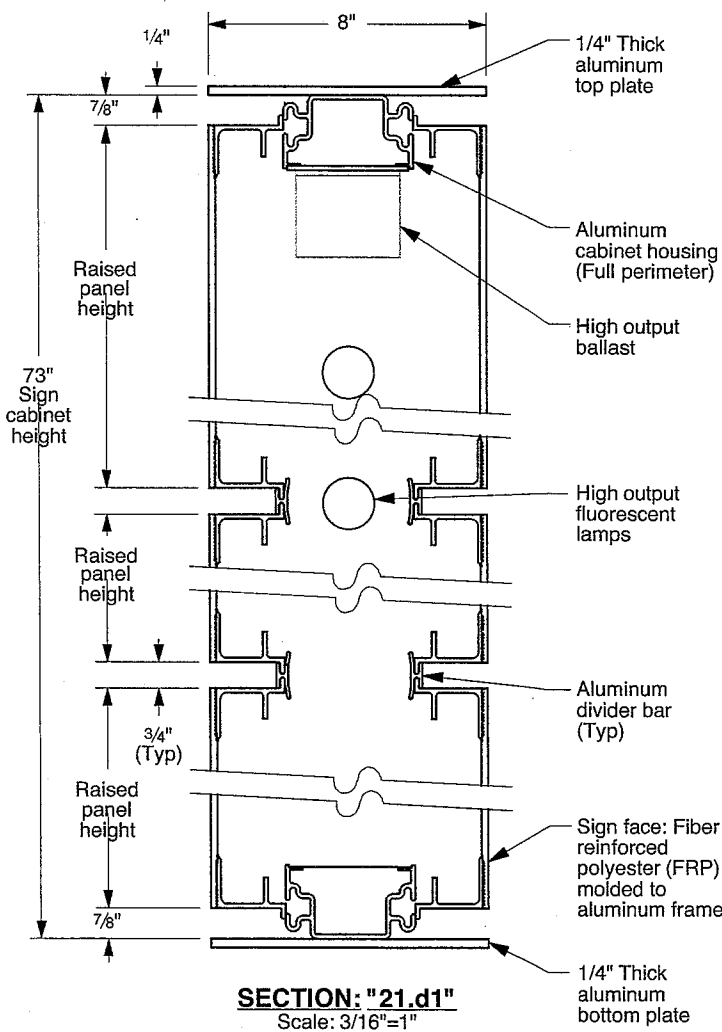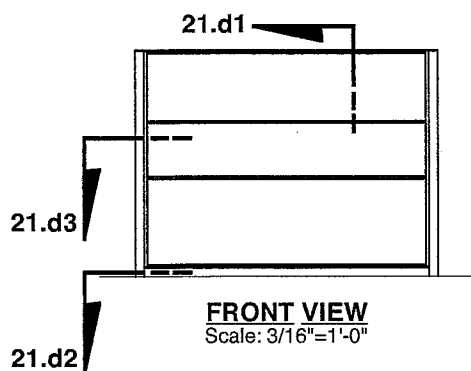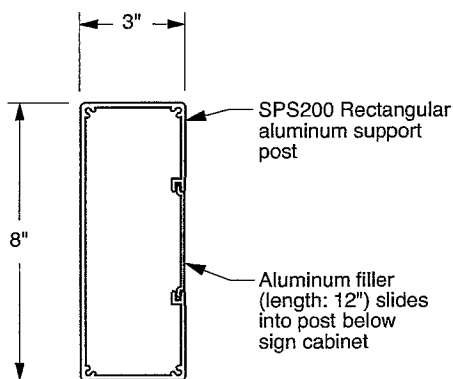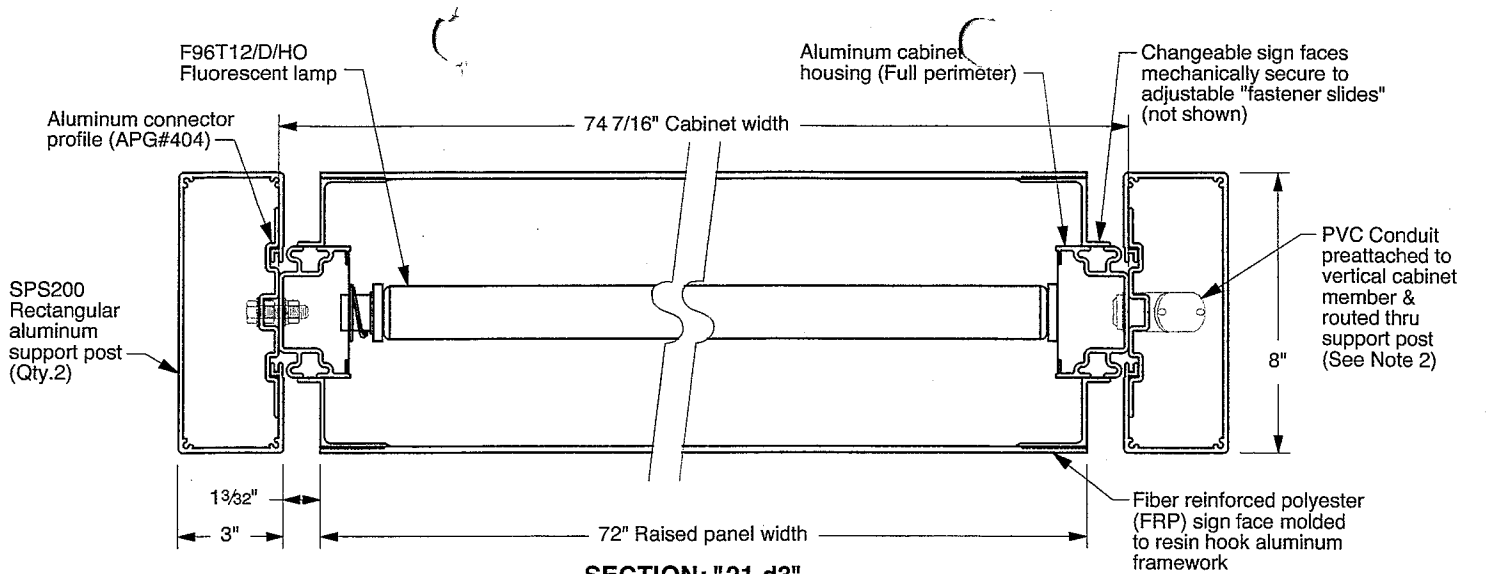

NOTES:

1. Refer to presentation drawing and/or work order for colors, graphics specifications and sign panel sizes.
2. ___ V Electrical supply, conduit and associated fittings are by others. Installer to increase footing size as required to route conduit. Electrical connection performed by certified persons

Location(s)

21

**APPROVAL
REQUIRED**

BY: _____

DATE: _____




Atlanta, Georgia USA • Phone: (404) 688-9000 • Web: www.apcosigns.com

All Design Rights Reserved

Customer: North Austin Medical Center
Project: Exterior Main Entrance
Location '21' - Section Views
Product: 4420 MultiPanel PolySign
Double Post Mount, Illuminated


Date: 10/01/14
Drawn: WWD
Scale: As Shown
Coord.: DTS
W.O.#: 437581

Sheet: 21.d

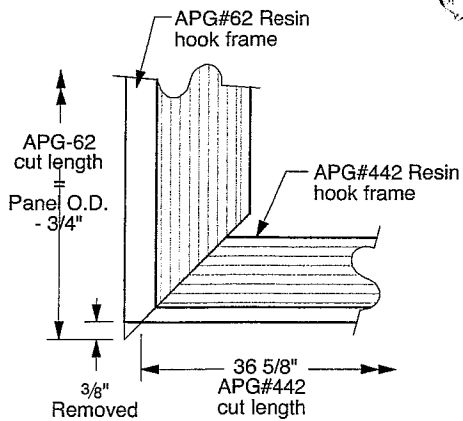


TYPICAL CORNER DETAIL
Scale: 1/4"=1"

APG#62 Resin hook frame (Left & right sides)

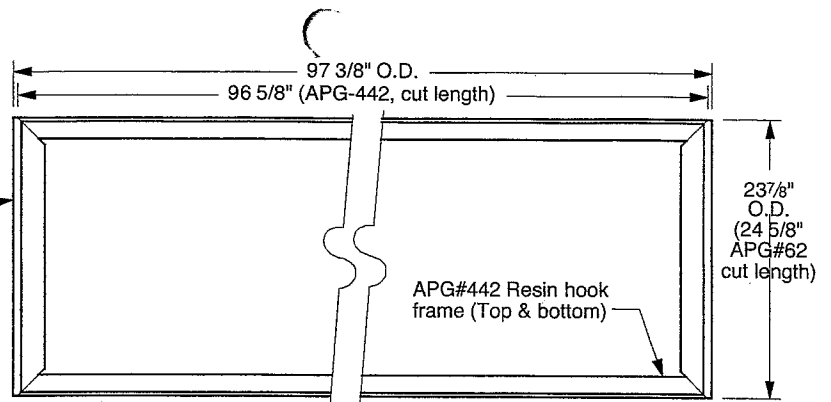


MP2472-I
Scale: 3/4"=1'-0"
(Qty.2, FRP not shown)

APG#62 Resin hook frame (Left & right sides)

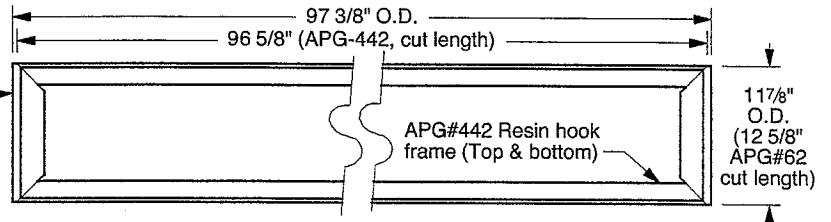

MP1272-I
Scale: 3/4"=1'-0"
(Qty.2, FRP not shown)

APG#62 Resin hook frame (Left & right sides)

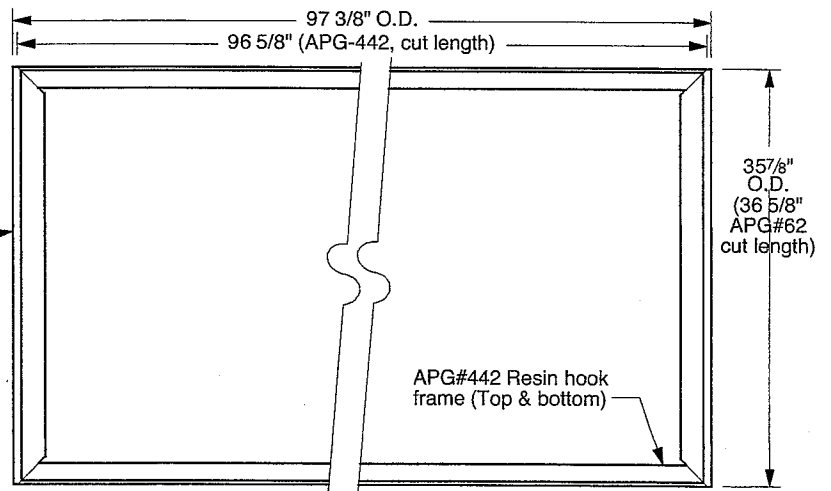

MP3672-I
Scale: 3/4"=1'-0"
(Qty.2, FRP not shown)

Location(s)
21

NOTES:

1. Refer to presentation drawing and/or work order for colors, graphics specifications and sign panel sizes.

APPROVAL REQUIRED

BY: _____
DATE: _____




Atlanta, Georgia USA • Phone: (404) 688-9000 • Web: www.apcosigns.com

All Design Rights Reserved


Customer: North Austin Medical Center
Project: Exterior Main Entrance
Location '21' - Section Views
Product: 4420 MultiPanel PolySign
Double Post Mount, Illuminated

Date: 10/01/14
Drawn: WWD
Scale: As Shown
Coord.: DTS
W.O.#: 437581

Sheet: 21.e

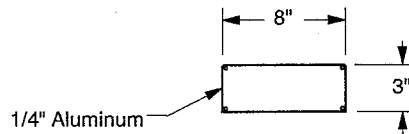

WJ POST CAP
Scale: 1"=1'-0"

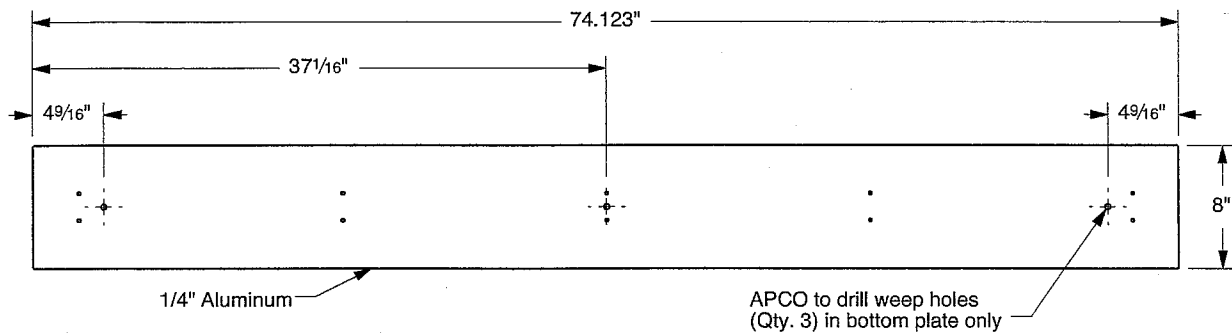

WJ TOP/BOTTOM PLATE
Scale: 1"=1'-0"

Location(s)
21

NOTES:

1. Refer to presentation drawing and/or work order for colors, graphics specifications and sign panel sizes.

APPROVAL REQUIRED BY: _____
DATE: _____



Atlanta, Georgia USA • Phone: (404) 688-9000 • Web: www.apcosigns.com


All Design Rights Reserved

Customer: North Austin Medical Center
Project: Exterior Main Entrance
Location '21' - Water-Jet Parts
Product: 4420 MultiPanel PolySign
Double Post Mount, Illuminated

Date: 10/01/14
Drawn: WWD
Scale: As Shown
Coord.: DTS
W.O.#: 437581

Sheet: 21.f

Revisions	Date	Check
Wall increased from .125" to .140". Tolerance added & screwways changed from 90° to 60°	12/16/03	RCB
Redrawn in Graphite	12/06/06	WWD

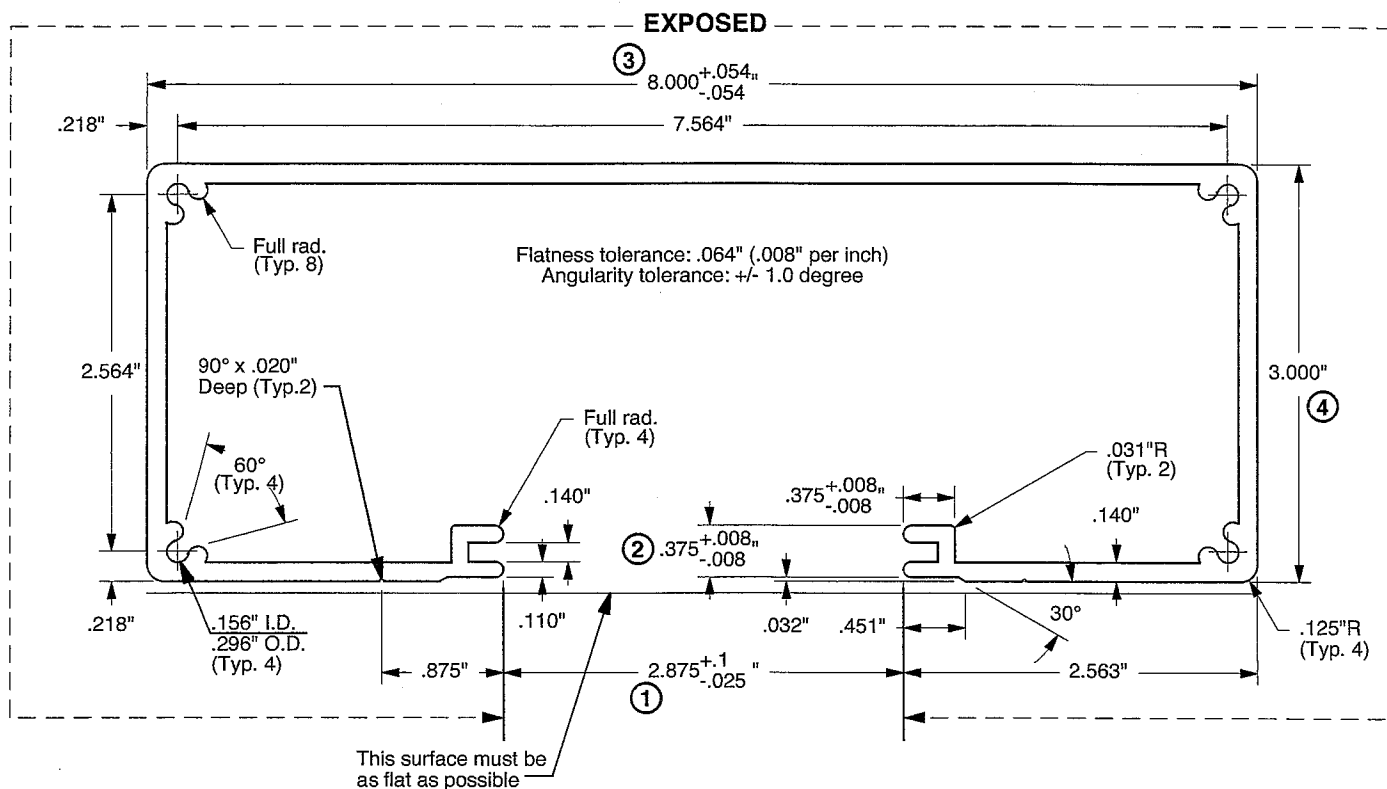

APG#21A

Wt. Per Area 1.2
Perimeter 40.242
Area 2.753
Weight 3.303
Centroid X -0
Centroid Y .769
Inertia IXX 4.422
Inertia IYY 25.196
Inertia IXY .001

Notes:

- All design rights reserved.
- All dimensions are in inches unless otherwise noted.
- Numbered Bullets are Primary Inspected Areas.

APCO

Atlanta, Georgia USA • Phone: (404) 688-9000 • Web: www.apcosigns.com

Aluminum Assoc. Std. Tolerances Apply Unless Shown Otherwise		Solid () Semi-Hollow () Hollow I (x) Hollow II ()	Unspecified Corners 0.010"R 0.25 mm	Typ. Wall Unless Noted 0.140" 3.56 mm	Scale 3/4" = 1"	Date 12/09/03
Est. Area 2.753	Est. Weight 3.303 lbs./ft. 4.919 kg/m		Alloy 6063-T5	Finish Mill	Die Status Active	Order Code SPS200
Est. Perimeter 40.242" Ext. na Int.	USA Stock Length 24'-1"	Drawn JMM	Description Post 3" x 8" Rectangular			APG- 21A

LOC 21



FIRE LANE - TOW AWAY ZONE



CASE #

#24

**CITY OF AUSTIN
APPLICATION TO SIGN REVIEW BOARD
SIGN VARIANCE**

WARNING: Filing of this appeal stops all affected construction activity.

PLEASE: TYPE AND COMPLETE ALL REQUESTED INFORMATION.

STREET ADDRESS: 12221 N Mo-Pac Expressway Austin, TX 78758

LEGAL DESCRIPTION: Subdivision – 36.3670 A

Lot(s) 1 Block B Outlot Centrum Division The Resub of Blk B & E

I/We Michael A. Hunter on behalf of myself/ourselves as authorized agent for

St. David's North Austin Medical Center affirm that on October, 2014, hereby apply for a hearing before

the Sign Review Board for consideration:

ERECT – ATTACH – COMPLETE – REMODEL – MAINTAIN

Erect a new monument directional sign

in a _____ zoning district and located within the Scenic Roadway
Sign District.

If your variance request is for a reduction in setbacks or height limits, please contact Eben Kellogg with the Electric Utility at (512)322-6050 and send him a scan of your request to eben.kellogg@austinenenergy.com before filing your application with this office to discuss your request. The Electric Utility will recommend the board deny your request if it will result in an encroachment into an electric easement or a NESC violation.

NOTE: The Board must determine the existence of, sufficiency of and weight of evidence supporting the findings described below. In order to grant your request for a variance, the Board must first make one or more of the findings described under 1, 2, and 3 below; the Board must then make the finding described in item 4 below. If the Board cannot make the required findings, it cannot approve a sign variance.

Therefore, you must complete each of the applicable Findings Statements as part of your application. Failure to do so may result in your application being rejected as incomplete. Please attach any additional support documents.

VARIANCE FINDINGS: I contend that my entitlement to the requested variance is based on the following findings:

1. The variance is necessary because strict enforcement of the Article prohibits any reasonable opportunity to provide adequate signs on the site, considering the unique features of a site such as its dimensions, landscaping, or topography, because: The new proposed sign is of the same type and design as previously approved signs for this property in Phase 1 approximately 2 years ago.

OR,

2. The granting of this variance will not have a substantially adverse impact upon neighboring properties, because: We are replacing an existing sign of the same nature in the same location.

OR,

3. The granting of this variance will not substantially conflict with the stated purposes of this sign ordinance, because: The additional size is needed to convey directions to various medical facilities within the campus

AND,

4. Granting a variance would not provide the applicant with a special privilege not enjoyed by others similarly situated or potentially similarly situated, because: This is an emergency medical facility that needs to be able to convey directional information to those in need of emergency medical care.

APPLICANT CERTIFICATE – I affirm that my statements contained in the complete application are true and correct to the best of my knowledge and belief.

Signed Michael A. Hunter Mail Address 7733 Harwell St

City, State & Zip Fort Worth, Texas 76108

Printed Michael A Hunter Phone 817-246-4848 Date 10/30/2014

OWNERS CERTIFICATE – I affirm that my statements contained in the complete application are true and correct to the best of my knowledge and belief.

Signed Michael A. Hunter Mail Address 7733 Harwell St

City, State & Zip Fort Worth, Texas 76108

Printed Michael A. Hunter Phone 817-246-4848 Date 10/30/2014

SIGN SPECIFICATIONS



4420 PolySign Multi-Panel Series
Double Posts and Pylon
Internally Illuminated
Double Sided Graphics

Support Posts:

Part Code: SP520P" x 8" Rectangular/
Color: A46 Off White

Multi-Panel: (Side A & B Logo Panel)

MP242-423.25" x 72"
Backgnd. Color: A27 Deep Grey@opaque)

Illuminated Graphics:

Logo: LTBD (St. David's NAMC)
Size: 9"
Color: A01 White@translucent)

Copy: GoudyOldStyle BD BT
Size: 6 1/4" & 4 1/16" Small Caps
Color: A01 White@translucent)

Multi-Panel: (Side A Message Panel)

MP4872-447.25" x 72"
1rd. Color: A46 Off White@opaque)
Backgnd. Color: A46 Off White@opaque)

Illuminated Graphics:

Arrow: A120
Size: 6"
Color: DayLite@translucent)
Color: A69 American Red@translucent)

Copy: GoudyOldStyle BD BT

Size: 5"
Color: DayLite@translucent)
Color: A69 American Red@translucent)

Multi-Panel: (Side B Message Panel)

MP122-111.25" x 72"
Backgnd. Color: A46 Off White@opaque)

MP2072-119.25" x 72"

Backgnd. Color: A46 Off White@opaque)

MP122-111.25" x 72"

Backgnd. Color: A46 Off White@opaque)

MP527-281.25" x 72"

Backgnd. Color: A46 Off White@opaque)

MP527-281.25" x 72"

Backgnd. Color: A46 Off White@opaque)

MP527-281.25" x 72"

Backgnd. Color: A46 Off White@opaque)

MP527-281.25" x 72"

Backgnd. Color: A46 Off White@opaque)

MP527-281.25" x 72"

Backgnd. Color: A46 Off White@opaque)




MP527-281.25" x 72"

Backgnd. Color: A46 Off White@opaque)

MP527-281.25" x 72"

Backgnd. Color: A46 Off White@opaque)

PLAN VIEW

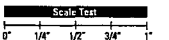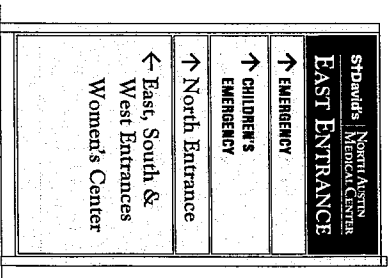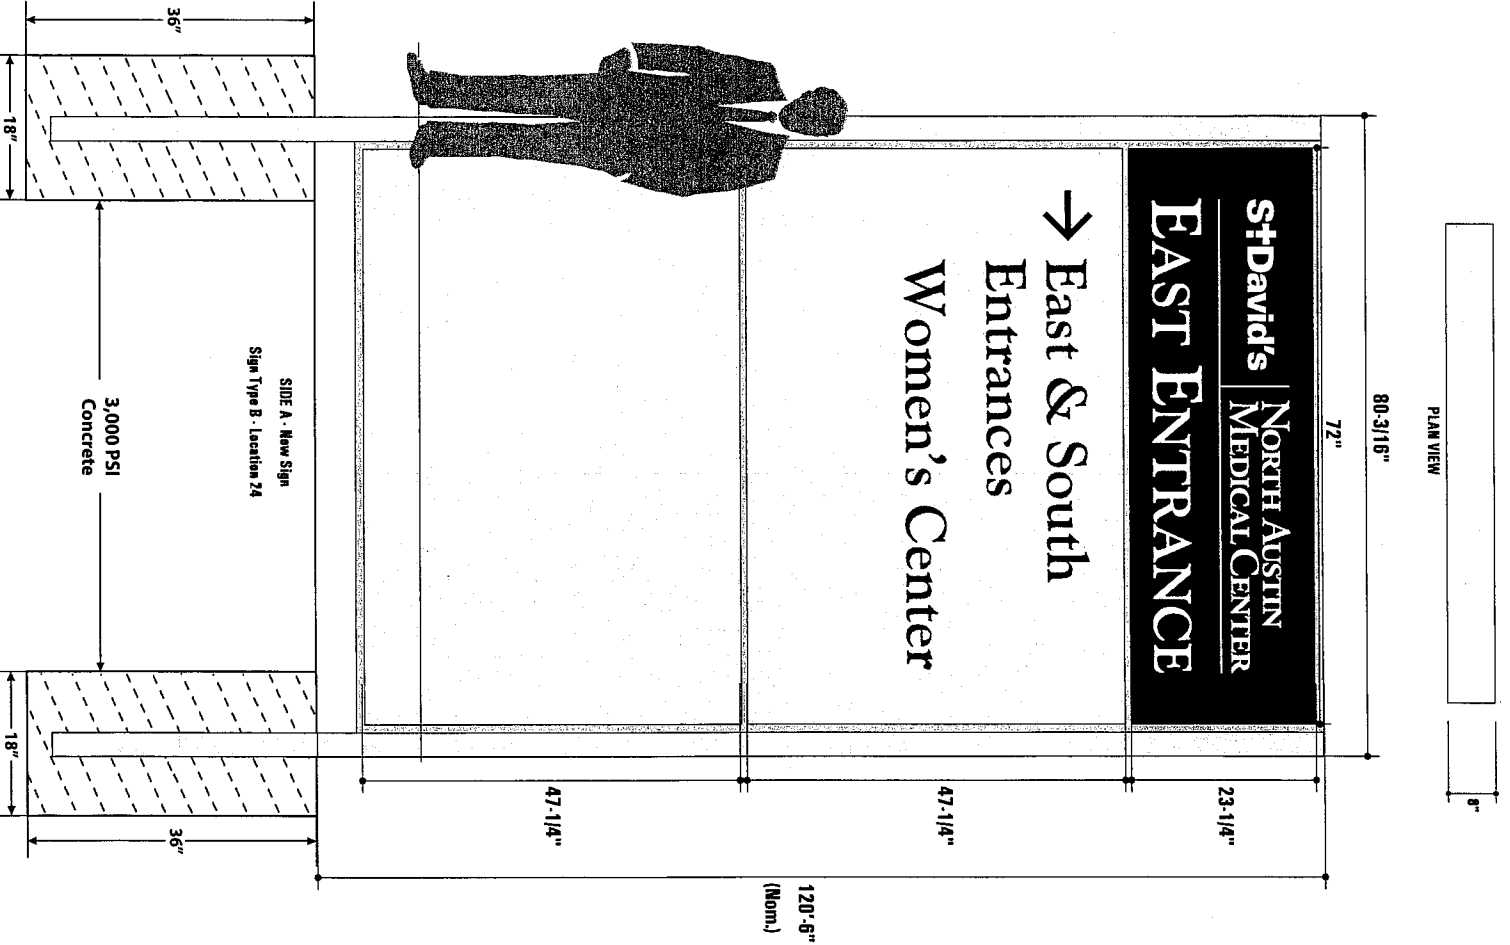

Colors depicted are a general representation of the color specified.
If color selection is critical, please request sample for approval.

Project Reference:		Status:	Date:	Drawn By:	Production Info:	Sign Type:
Project:	Children's EMERGENCY - North Austin Med. Ctr.	Draft	19, May 2014	RHK	Work Order #B D	B Location 24 4420 PolySign Series
Sales Rep:	Diana Barcafara	Revision	12, June 2014	RHK	Approved By:	
CSR/PM:		Revision	13, June 2014	RHK	Approved Date:	Scale: 1/2" = 1'-0"
		Revision	18, July 2014	RHK	Customer approval is required prior to production	
		Revision	25, Aug. 2014	RHK		
		Revision	27, Aug. 2014	RHK		


APCO

apcosigns.com



Corporate Headquarters
388 Grant Street SE
Atlanta, GA 30312-2227
Ph. 404.688.9000, Fax: 404.577.3847
Email: sales@apcosigns.com

■ Removing Existing & Replacing with New
■ Street Frontage

St. David's N. Austin Medical Center
12221 North Mopac Expwy., Austin, TX 78758

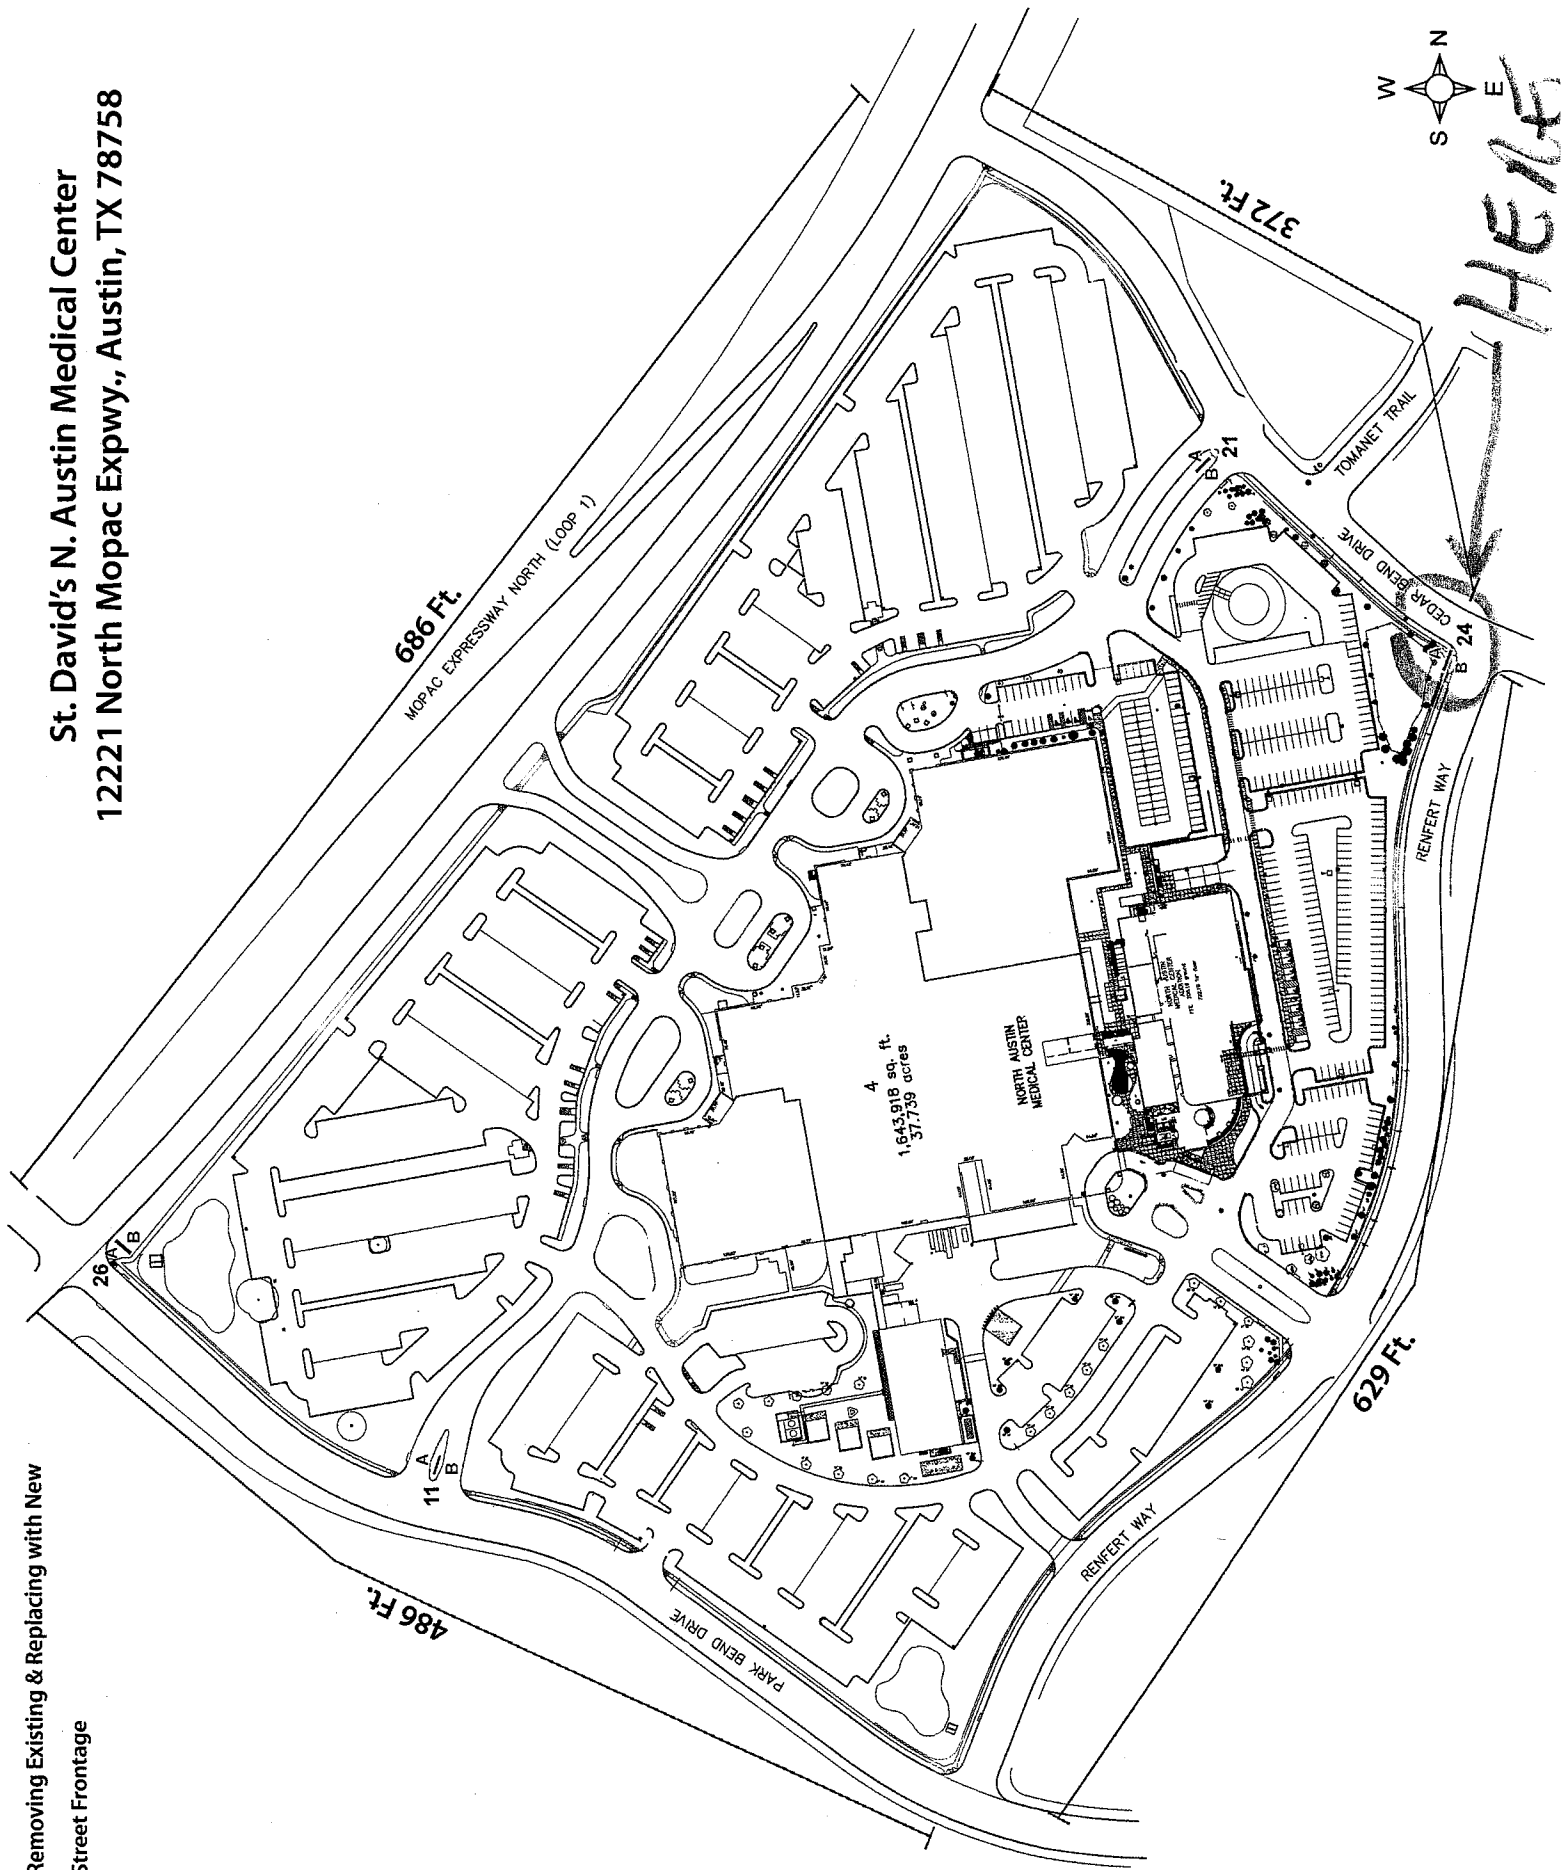


Location 24

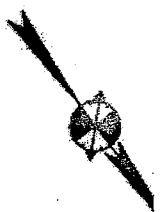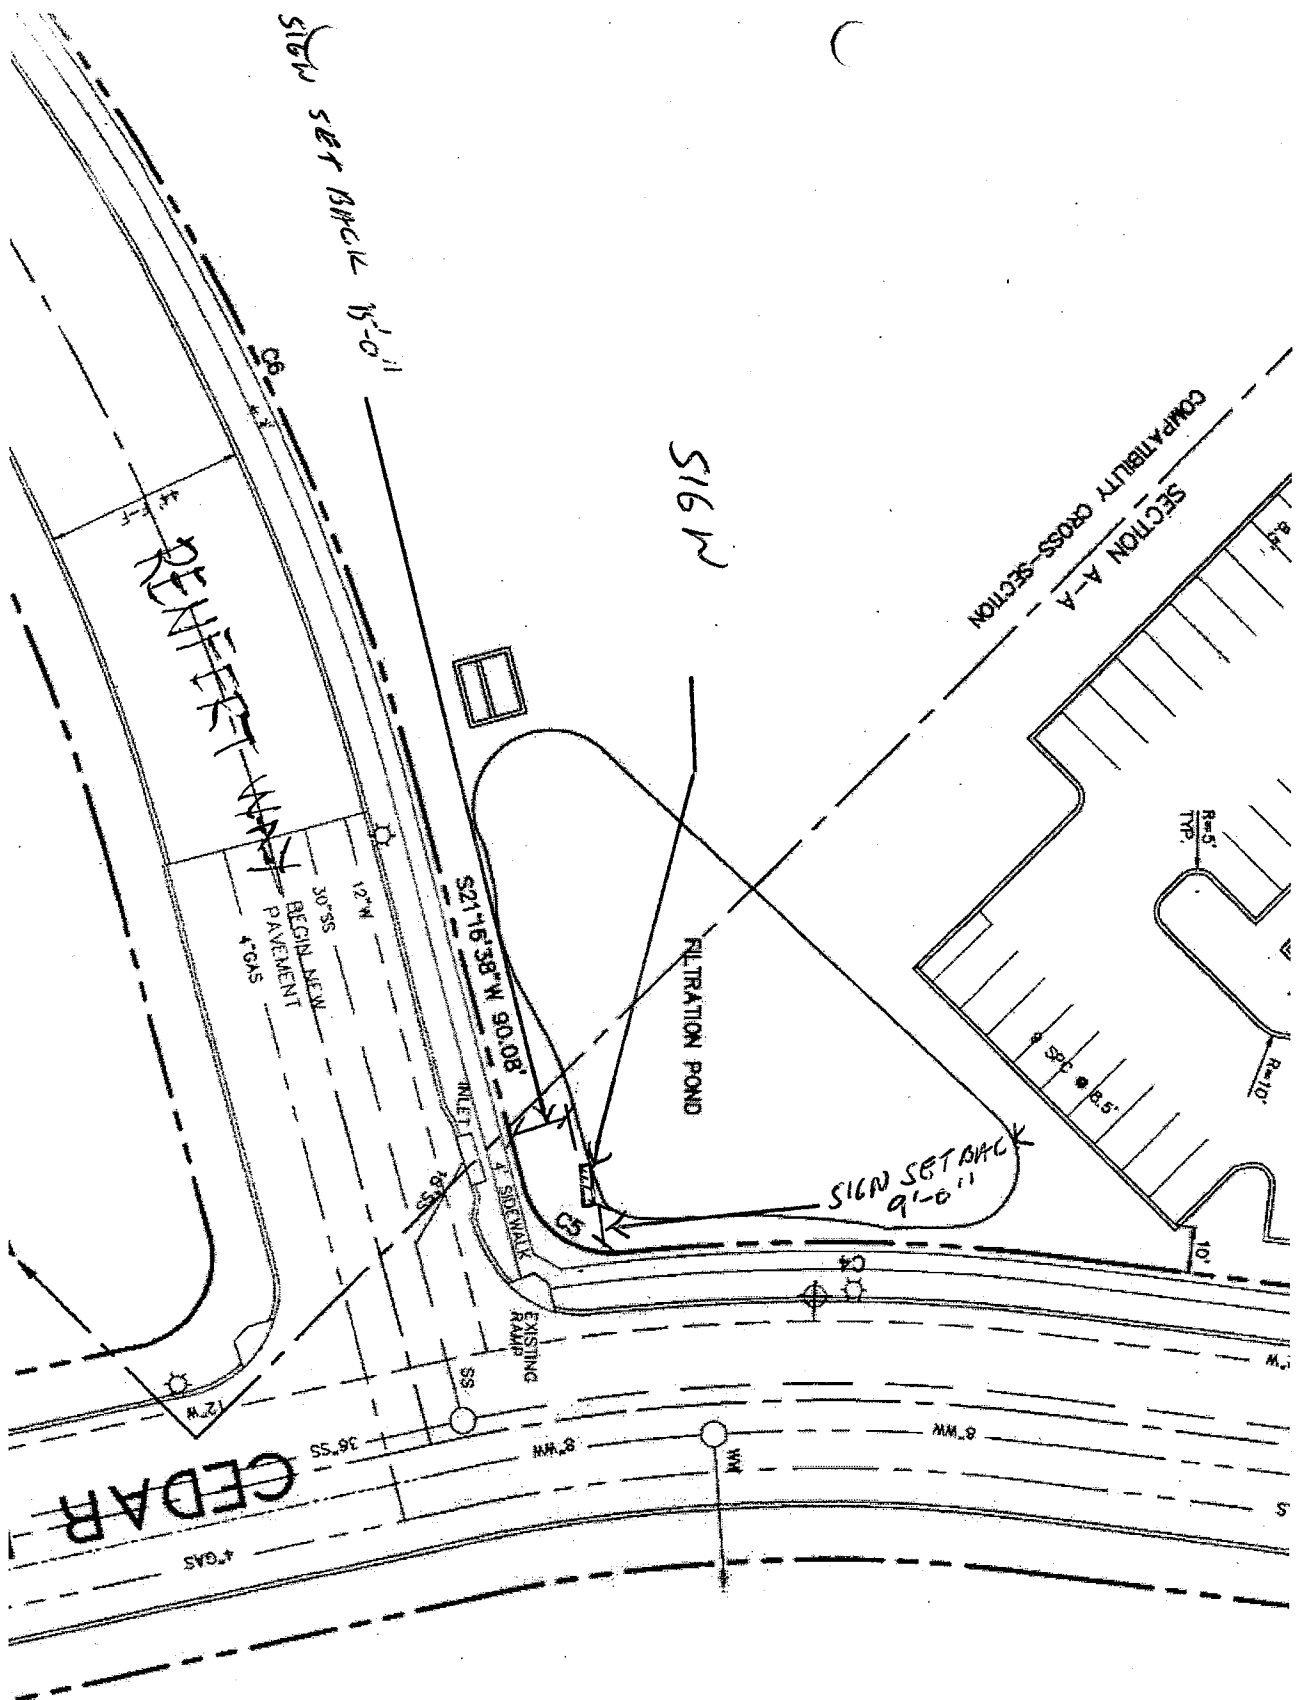


LEGEND

- ☆ LIGHT POLE
- POWER POLE
- ↓ DOWN GUY
- ⊕ FIRE HYDRANT
- ⊙ WATER VALVE
- ⊠ WATER METER
- ⊞ BENCHMARK
- ⊡ GAS METER
- ⊙ GAS VALVE
- WOOD FENCE
- CHAIN LINK FENCE
- WIRE FENCE
- ONE OVERHEAD ELECTRIC LINE
- TWO WASTEWATER MANHOLE
- (XXX) RECORD INFORMATION
- ⊙ ELECTRIC MANHOLE
- UNDERGROUND ELECTRIC
- SS — STORM SEWER MANHOLE
- WASTEWATER LINE
- SS — STORM SEWER LINE
- WATER LINE
- H/W HEADWALL
- S ROADWAY SIGN
- ⊙ TELEPHONE CABLE MARK
- ⊞ TELEPHONE CABLE RISER
- UG — UNDERGROUND TELEPHONE
- ⊙ TREES TO BE REMOVED
- ⊙ TREES TO REMAIN
- ⊙ H/C HANDICAP PARKING SPACE
- ⊙ H/C (V/S) HANDICAP VAN PARKING
- ⊞ PROPOSED GRATE INLET
- ⊞ PROPOSED WATER VALVE
- ⊞ PROPOSED FIRE HYDRANT
- ⊞ PROPOSED "ONE WAY ONE
- ⊞ PROPOSED "DO NOT ENTER
- ⊞ PROPOSED DIRECTIONAL A

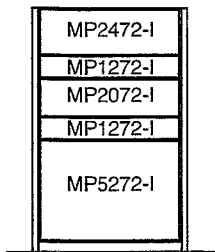


BACK VIEW
Scale: 1/8"=1'-0"

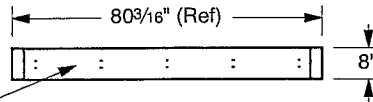


PLAN VIEW
Scale: 1/4"=1'-0"


Aluminum top plate
mechanically secured with non-
corrosive countersunk screws

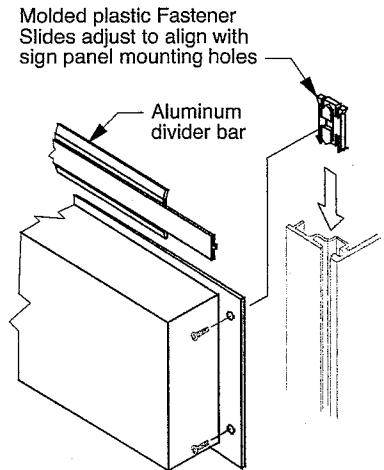

DETAIL '1': FASTENER SLIDE
Scale: None

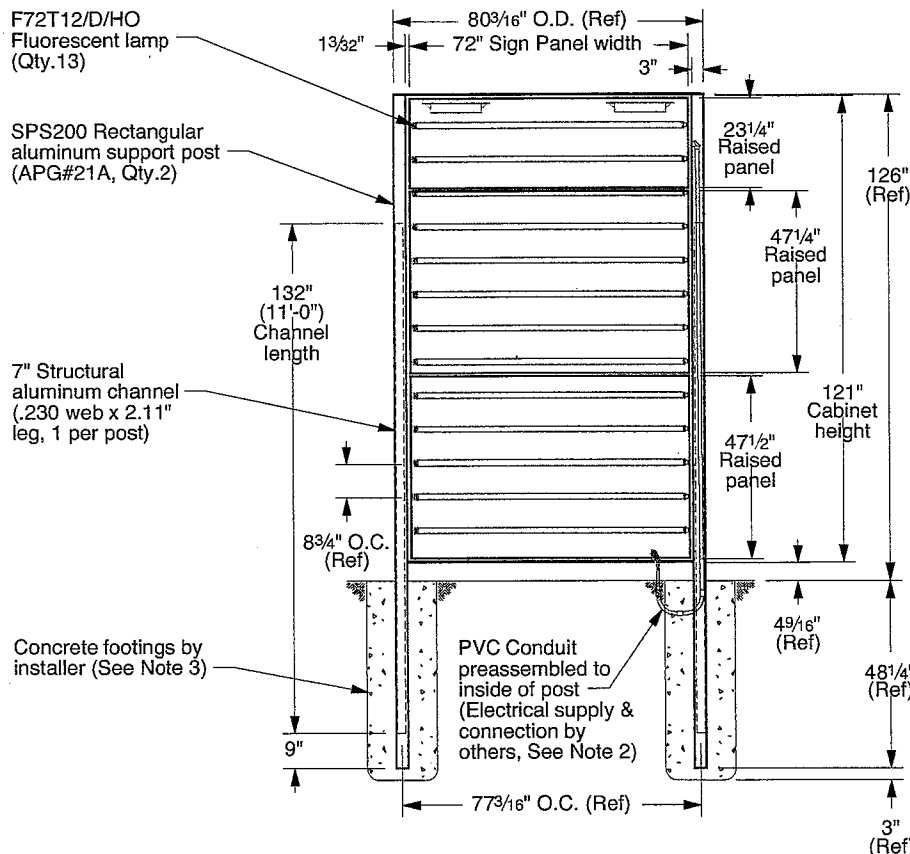

FRONT VIEW
Scale: 1/4"=1'-0"
(Side 'A' Shown)

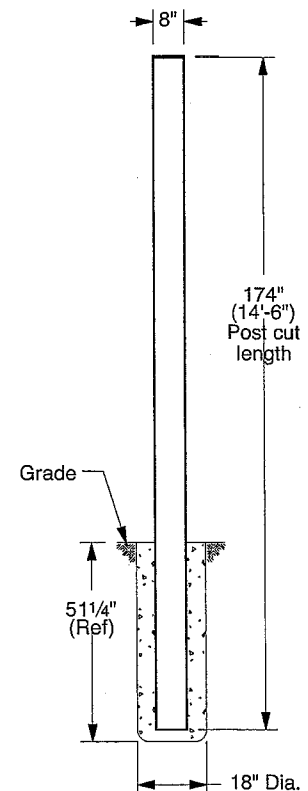

END VIEW
Scale: 1/4"=1'-0"

NOTES:

1. Refer to presentation drawing and/or work order for colors, graphics specifications and sign panel sizes.
2. ___ V Electrical supply, conduit and associated fittings are by others. Installer to increase footing size as required to route conduit. Electrical connection performed by certified persons.
3. Footings are shown for reference only. Actual design and installation performed by certified persons based on local codes and geographic practices.
4. Lifting bolts are provided to assist with sign installation. Lifting brackets are accessible by removing post caps. Remove bolts after installation and replace post caps.

Location(s)

24

**APPROVAL
REQUIRED**

BY: _____

DATE: _____

Atlanta, Georgia USA • Phone: (404) 688-9000 • Web: www.apcosigns.com

All Design Rights Reserved




apcosigns.com

Customer: North Austin Medical Center
Project: Exterior Main Entrance
Location '24' - Elevation Views
Product: 4420 MultiPanel PolySign
Double Post Mount, Illuminated


Date: 10/01/14
Drawn: WWD
Scale: As Shown
Coord.: DTS
W.O.#: 437581

Sheet: 24.a

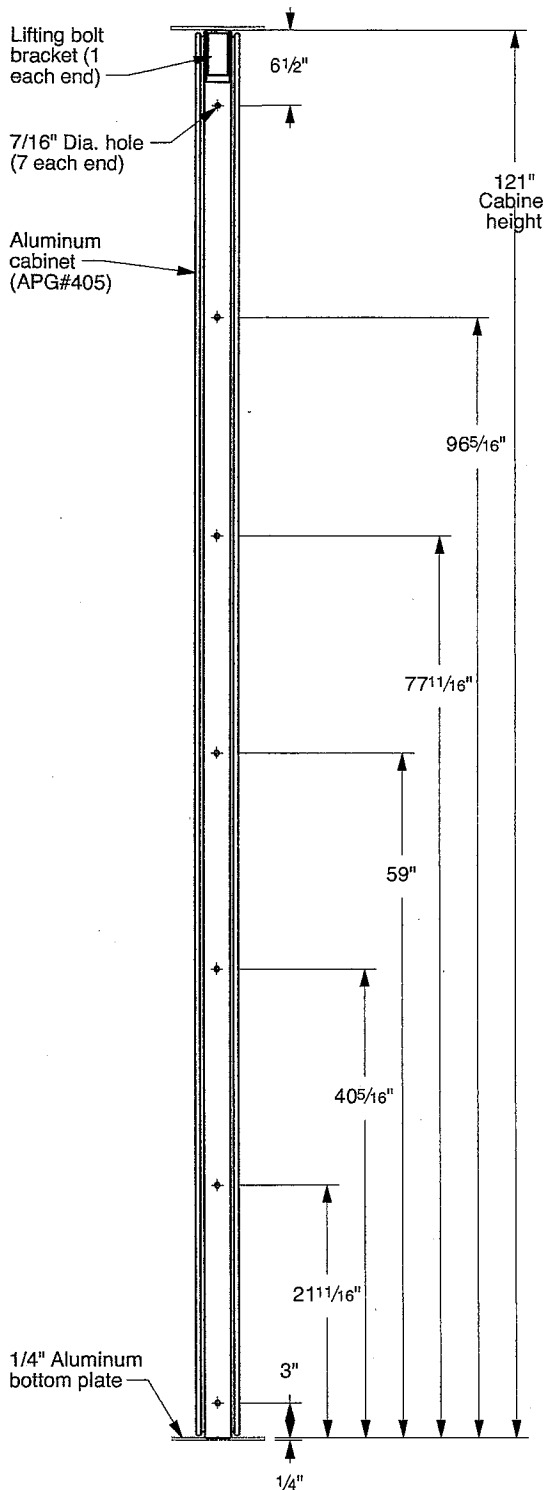


END VIEW: SIGN CABINET

Scale: 3/4"=1'-0"
 (Left end shown: Right end typical)

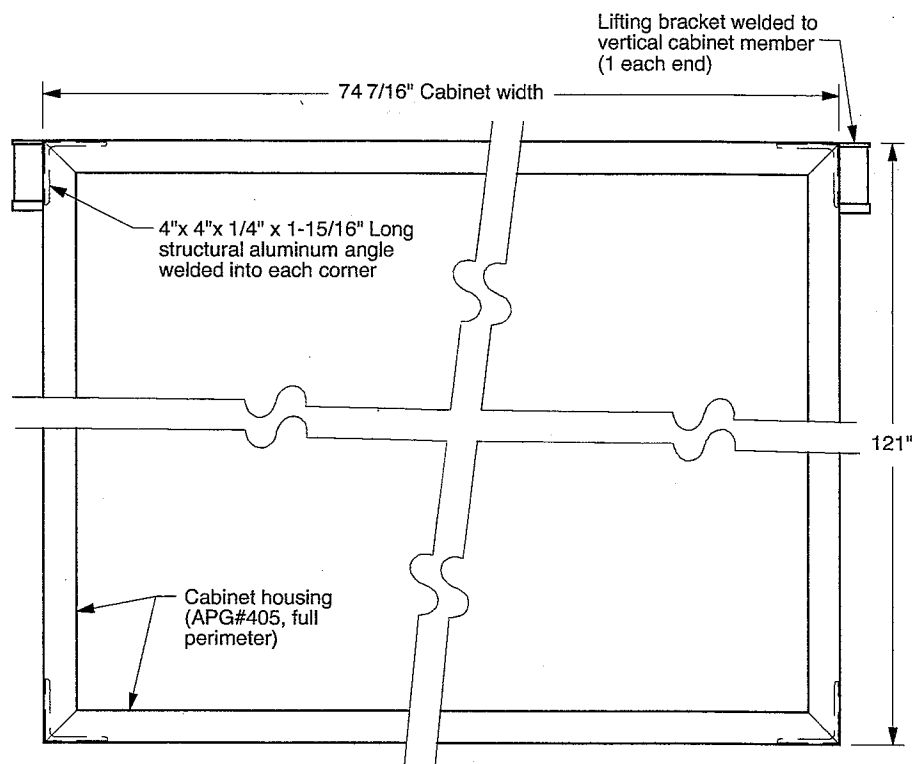

FRONT VIEW: SIGN CABINET

Scale: 1"=1'-0"

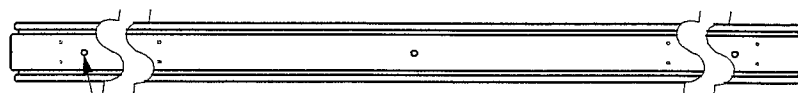

BOTTOM VIEW

Scale: 1"=1'-0"

Location(s)

24

NOTES:

1. Refer to presentation drawing and/or work order for colors, graphics specifications and sign panel sizes.

**APPROVAL
REQUIRED**

BY: _____

DATE: _____




Atlanta, Georgia USA • Phone: (404) 688-9000 • Web: www.apcosigns.com

All Design Rights Reserved

Customer: North Austin Medical Center
 Project: Exterior Main Entrance
 Location '24' - Cabinet Details
 Product: 4420 MultiPanel PolySign
 Double Post Mount, Illuminated

Date: 10/01/14
 Drawn: WWD
 Scale: As Shown
 Coord.: DTS
 W.O.#: 437581

Sheet: 24.b

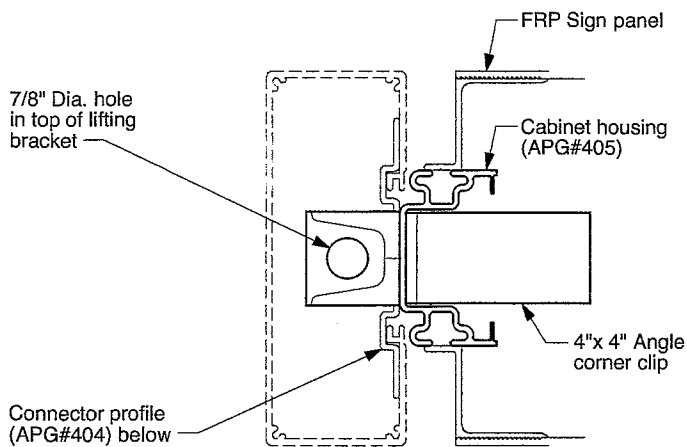

SECTION: "24.c1"
Scale: 1/4"=1"

Once sign is installed,
3/4" lifting bolt is
removed & post cap
is secured to post


1/4" Thick aluminum
post cap attached with
non-corrosive #10-24
flat head screws
(provided)

Lifting bracket
welded to
cabinet


3/4-10 UNC
Threaded hole
thru bottom of
lifting bracket

Connector
profile
(APG#404)


4"x 4"x 1/4" x 1-15/16"
Long structural
aluminum angle welded
into each cabinet corner

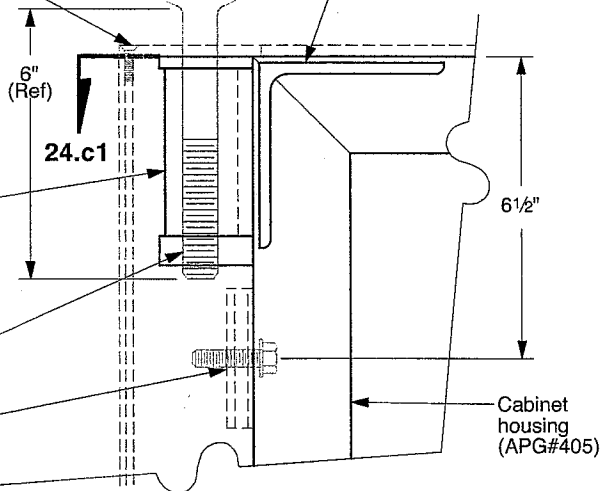


**FRONT SECTION VIEW @
LIFTING BRACKET**
Scale: 1/4"=1"

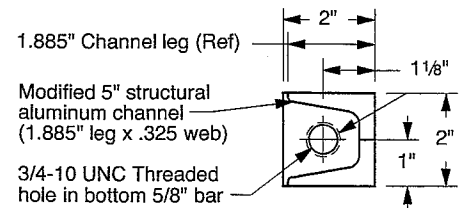


SECTION: "24.c2"
Scale: 1/4"=1"

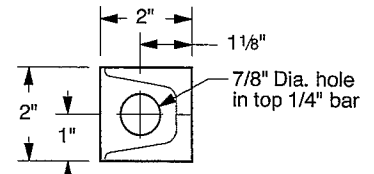

PLAN VIEW
Scale: 1/4"=1"

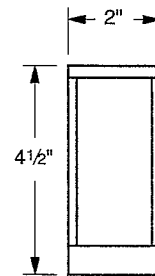

END VIEW
Scale: 1/4"=1"

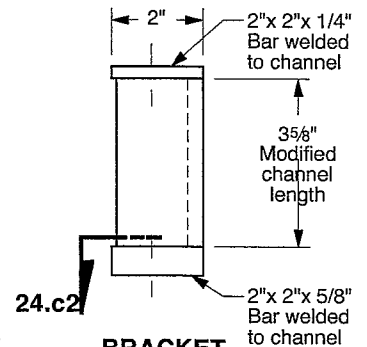

**BRACKET
FRONT VIEW**
Scale: 1/4"=1"

NOTES:

1. Lifting bolts are provided to assist with sign installation. Lifting brackets are accessible by removing post caps. In order to maintain structural integrity of the cabinet, use spreader beam and maintain a 90° angle between cabinet and both lifting bolts. Remove bolts after installation and replace post caps.

Location(s)

24

**APPROVAL
REQUIRED**

BY: _____

DATE: _____




Atlanta, Georgia USA • Phone: (404) 688-9000 • Web: www.apcosigns.com

All Design Rights Reserved


Customer: North Austin Medical Center
Project: Exterior Main Entrance
Location '24' - Lifting Bracket Details
Product: 4420 MultiPanel PolySign
Double Post Mount, Illuminated

Date: 10/01/14
Drawn: WWD
Scale: As Shown
Coord.: DTS
W.O.#: 437581


Sheet: 24.c

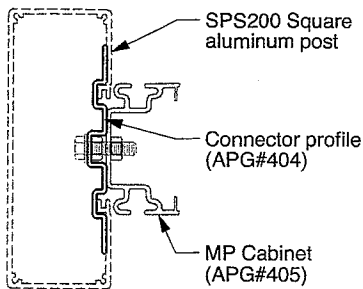

SECTION: "24.d1"
Scale: 3/16"=1"

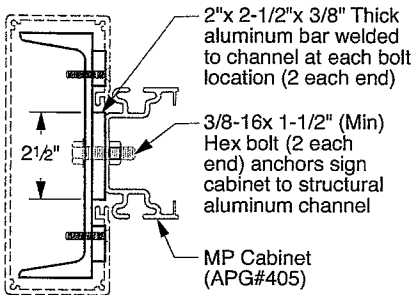

SECTION: "24.d2"
Scale: 3/16"=1"

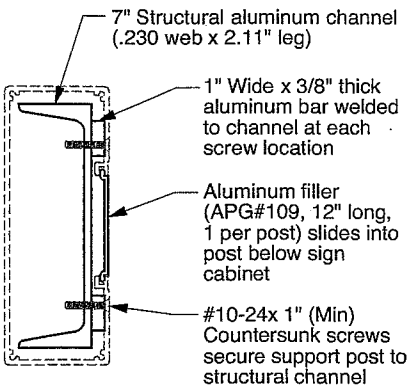


SECTION: "24.d3"
Scale: 3/16"=1"

24.d1

24.d2

24.d3

FRONT VIEW
Scale: 1/2"=1'-0"

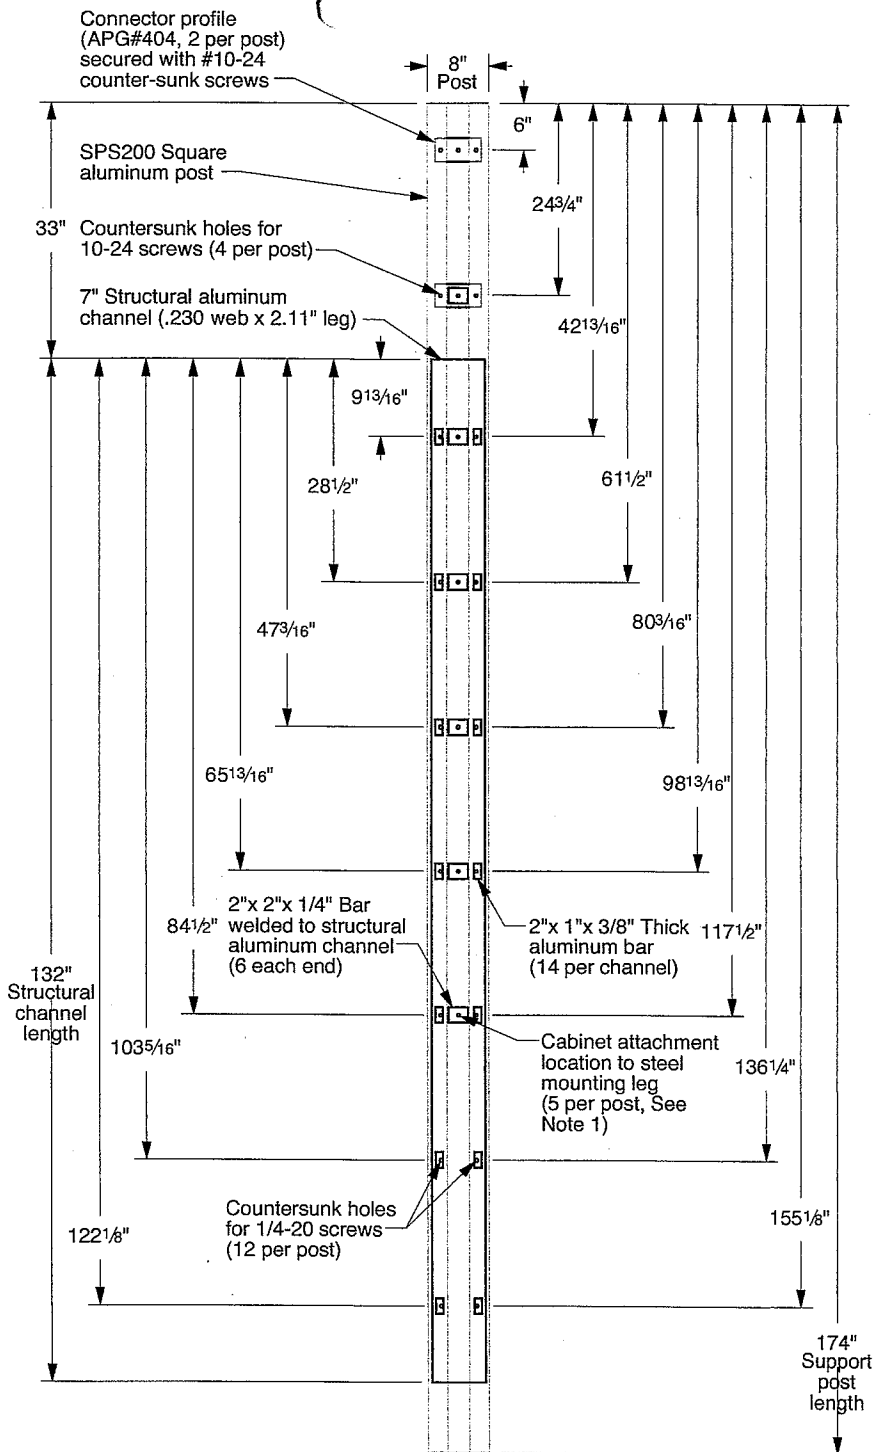

**INSIDE VIEW:
STRUCTURAL CHANNEL**
Scale: 1/2"=1'-0"

NOTES:

1. Lifting bolts are provided to assist with sign installation. Lifting brackets are accessible by removing post caps. In order to maintain structural integrity of the cabinet, use spreader beam and maintain a 90° angle between cabinet and both lifting bolts. Remove bolts after installation and replace post caps.

Location(s)
24

**APPROVAL
REQUIRED**

BY: _____
DATE: _____






Atlanta, Georgia USA • Phone: (404) 688-9000 • Web: www.apcosigns.com

All Design Rights Reserved

Customer: North Austin Medical Center
Project: Exterior Main Entrance
Location '24' - Structural Channel Details
Product: 4420 MultiPanel PolySign
Double Post Mount, Illuminated

Date: 10/01/14
Drawn: WWD
Scale: As Shown
Coord.: DTS
W.O.#: 437581

Sheet: 24.d

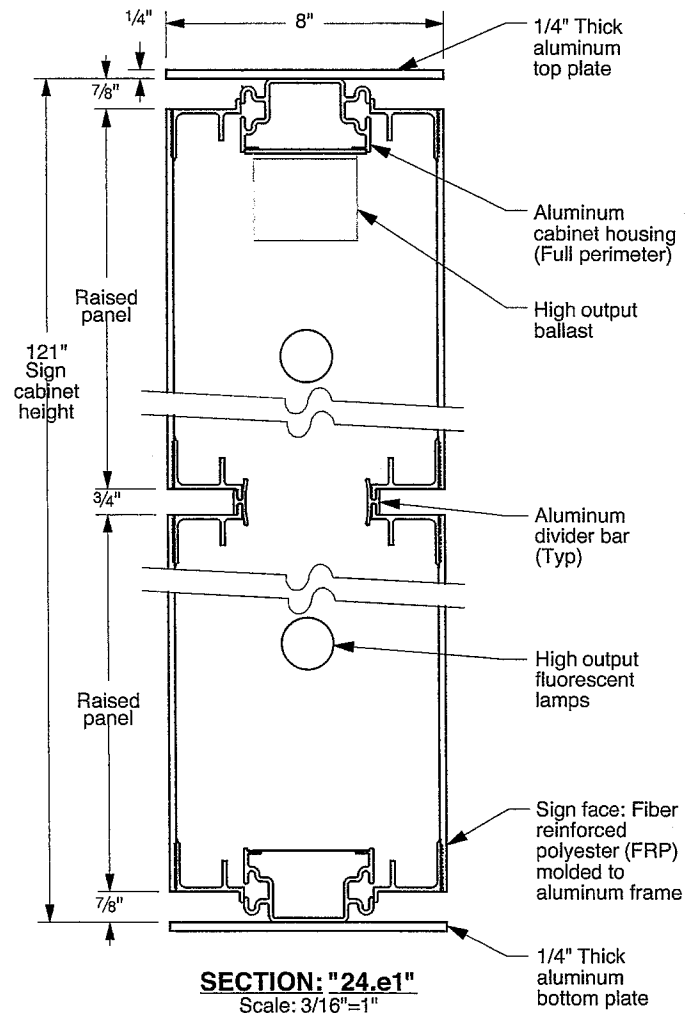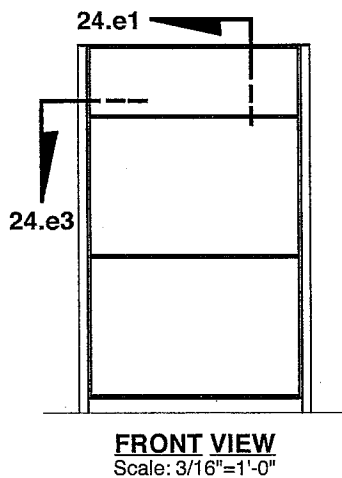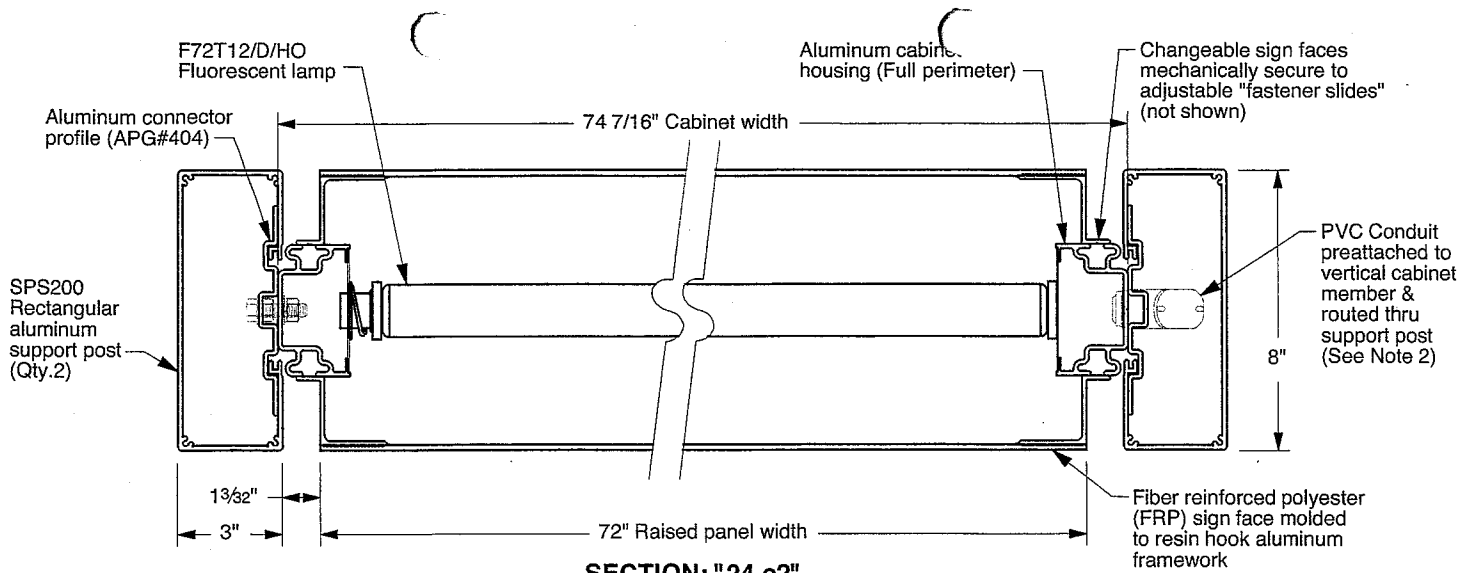

NOTES:

1. Refer to presentation drawing and/or work order for colors, graphics specifications and sign panel sizes.
2. ____V Electrical supply, conduit and associated fittings are by others. Installer to increase footing size as required to route conduit. Electrical connection performed by certified persons.

Location(s)
24

**APPROVAL
REQUIRED**

BY: _____
DATE: _____




Atlanta, Georgia USA • Phone: (404) 688-9000 • Web: www.apcosigns.com

All Design Rights Reserved


Customer: North Austin Medical Center
Project: Exterior Main Entrance
Location '24' - Section Views
Product: 4420 MultiPanel PolySign
Double Post Mount, Illuminated

Date: 10/01/14
Drawn: WWD
Scale: As Shown
Coord.: DTS
W.O.#: 437581


Sheet: 24.e

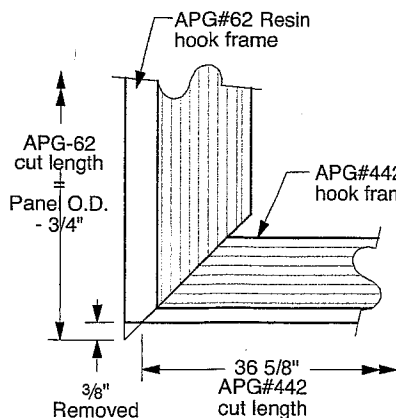


TYPICAL CORNER DETAIL
Scale: 1/4"=1"

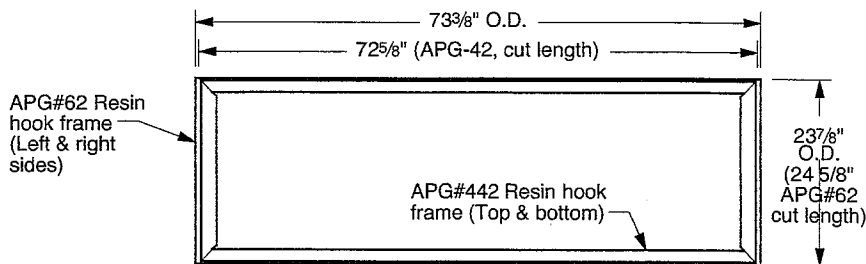


MP2472-I
Scale: 1/2"=1'-0"
(Qty. 2, FRP not shown)

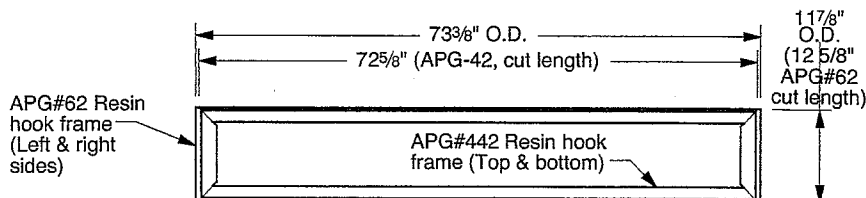


MP1272-I
Scale: 1/2"=1'-0"
(Qty. 2, FRP not shown)

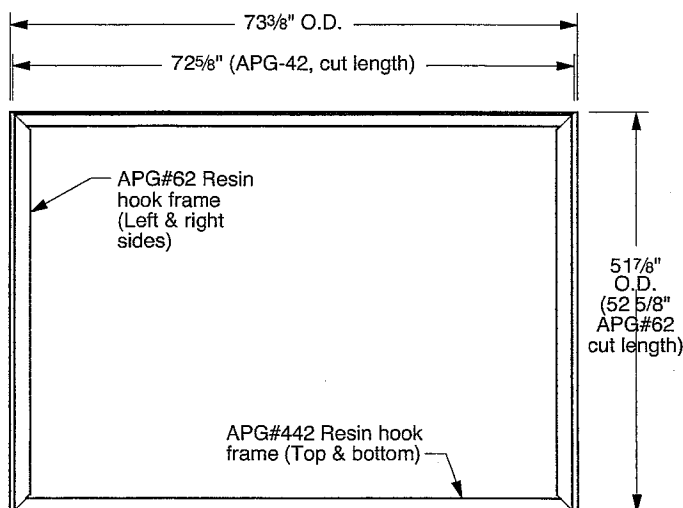

MP5272-I
Scale: 1/2"=1'-0"
(Qty. 1, FRP not shown)

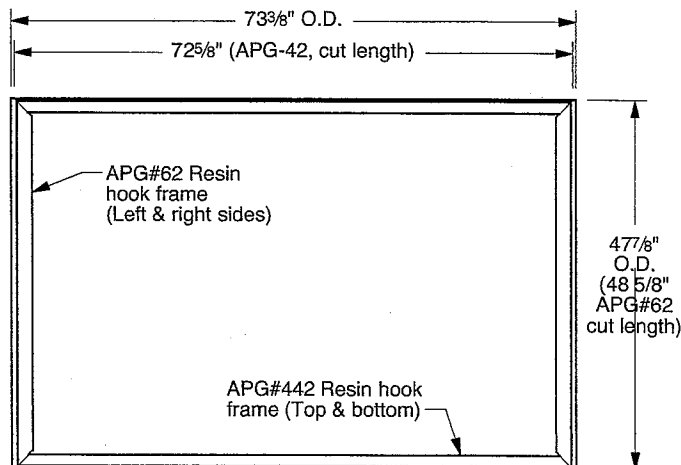

MP4872-I
Scale: 1/2"=1'-0"
(Qty. 2, FRP not shown)

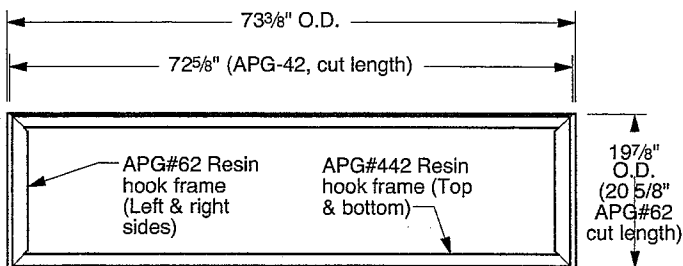

MP2072-I
Scale: 1/2"=1'-0"
(Qty. 1, FRP not shown)

Location(s)
24

NOTES:

1. Refer to presentation drawing and/or work order for colors, graphics specifications and sign panel sizes.

**APPROVAL
REQUIRED**

BY: _____
DATE: _____




Atlanta, Georgia USA • Phone: (404) 688-9000 • Web: www.apcosigns.com

All Design Rights Reserved


Customer: North Austin Medical Center
Project: Exterior Main Entrance
Location: '24' - Sign Panel Details
Product: 4420 MultiPanel PolySign
Double Post Mount, Illuminated

Date: 10/01/14
Drawn: WWD
Scale: As Shown
Coord.: DTS
W.O.#: 437581

Sheet: 24.f

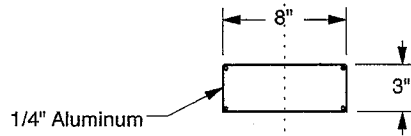

WJ POST CAP
Scale: 1"=1'-0"

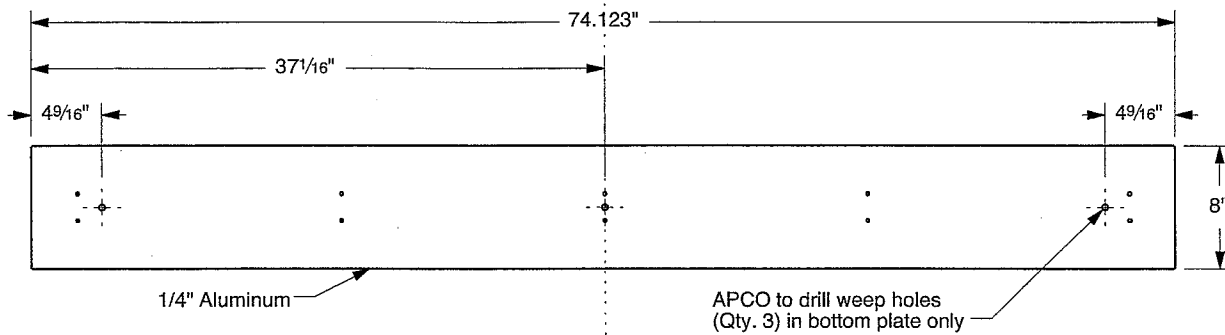

WJ TOP/BOTTOM PLATE
Scale: 1"=1'-0"

Location(s)
24

NOTES:

1. Refer to presentation drawing and/or work order for colors, graphics specifications and sign panel sizes.

**APPROVAL
REQUIRED**

BY: _____
DATE: _____



Atlanta, Georgia USA • Phone: (404) 688-9000 • Web: www.apcosigns.com

All Design Rights Reserved

Customer: North Austin Medical Center
Project: Exterior Main Entrance
Location '24' - Water-Jet Parts
Product: 4420 MultiPanel PolySign
Double Post Mount, Illuminated

Date: 10/01/14
Drawn: WWD
Scale: As Shown
Coord.: DTS
W.O.#: 437581

Sheet: 24.g

→ WOMEN'S CENTER
→ SOUTH ENTRANCE

100048

NORTH AUSTIN MEDICAL CENTER

AUSTIN DIAGNOSTIC CLINIC


← 24 HR. EMERGENCY

← WOMEN'S CENTER

← SOUTH ENTRANCE

← MAIN ENTRANCE

← NORTH ENTRANCE

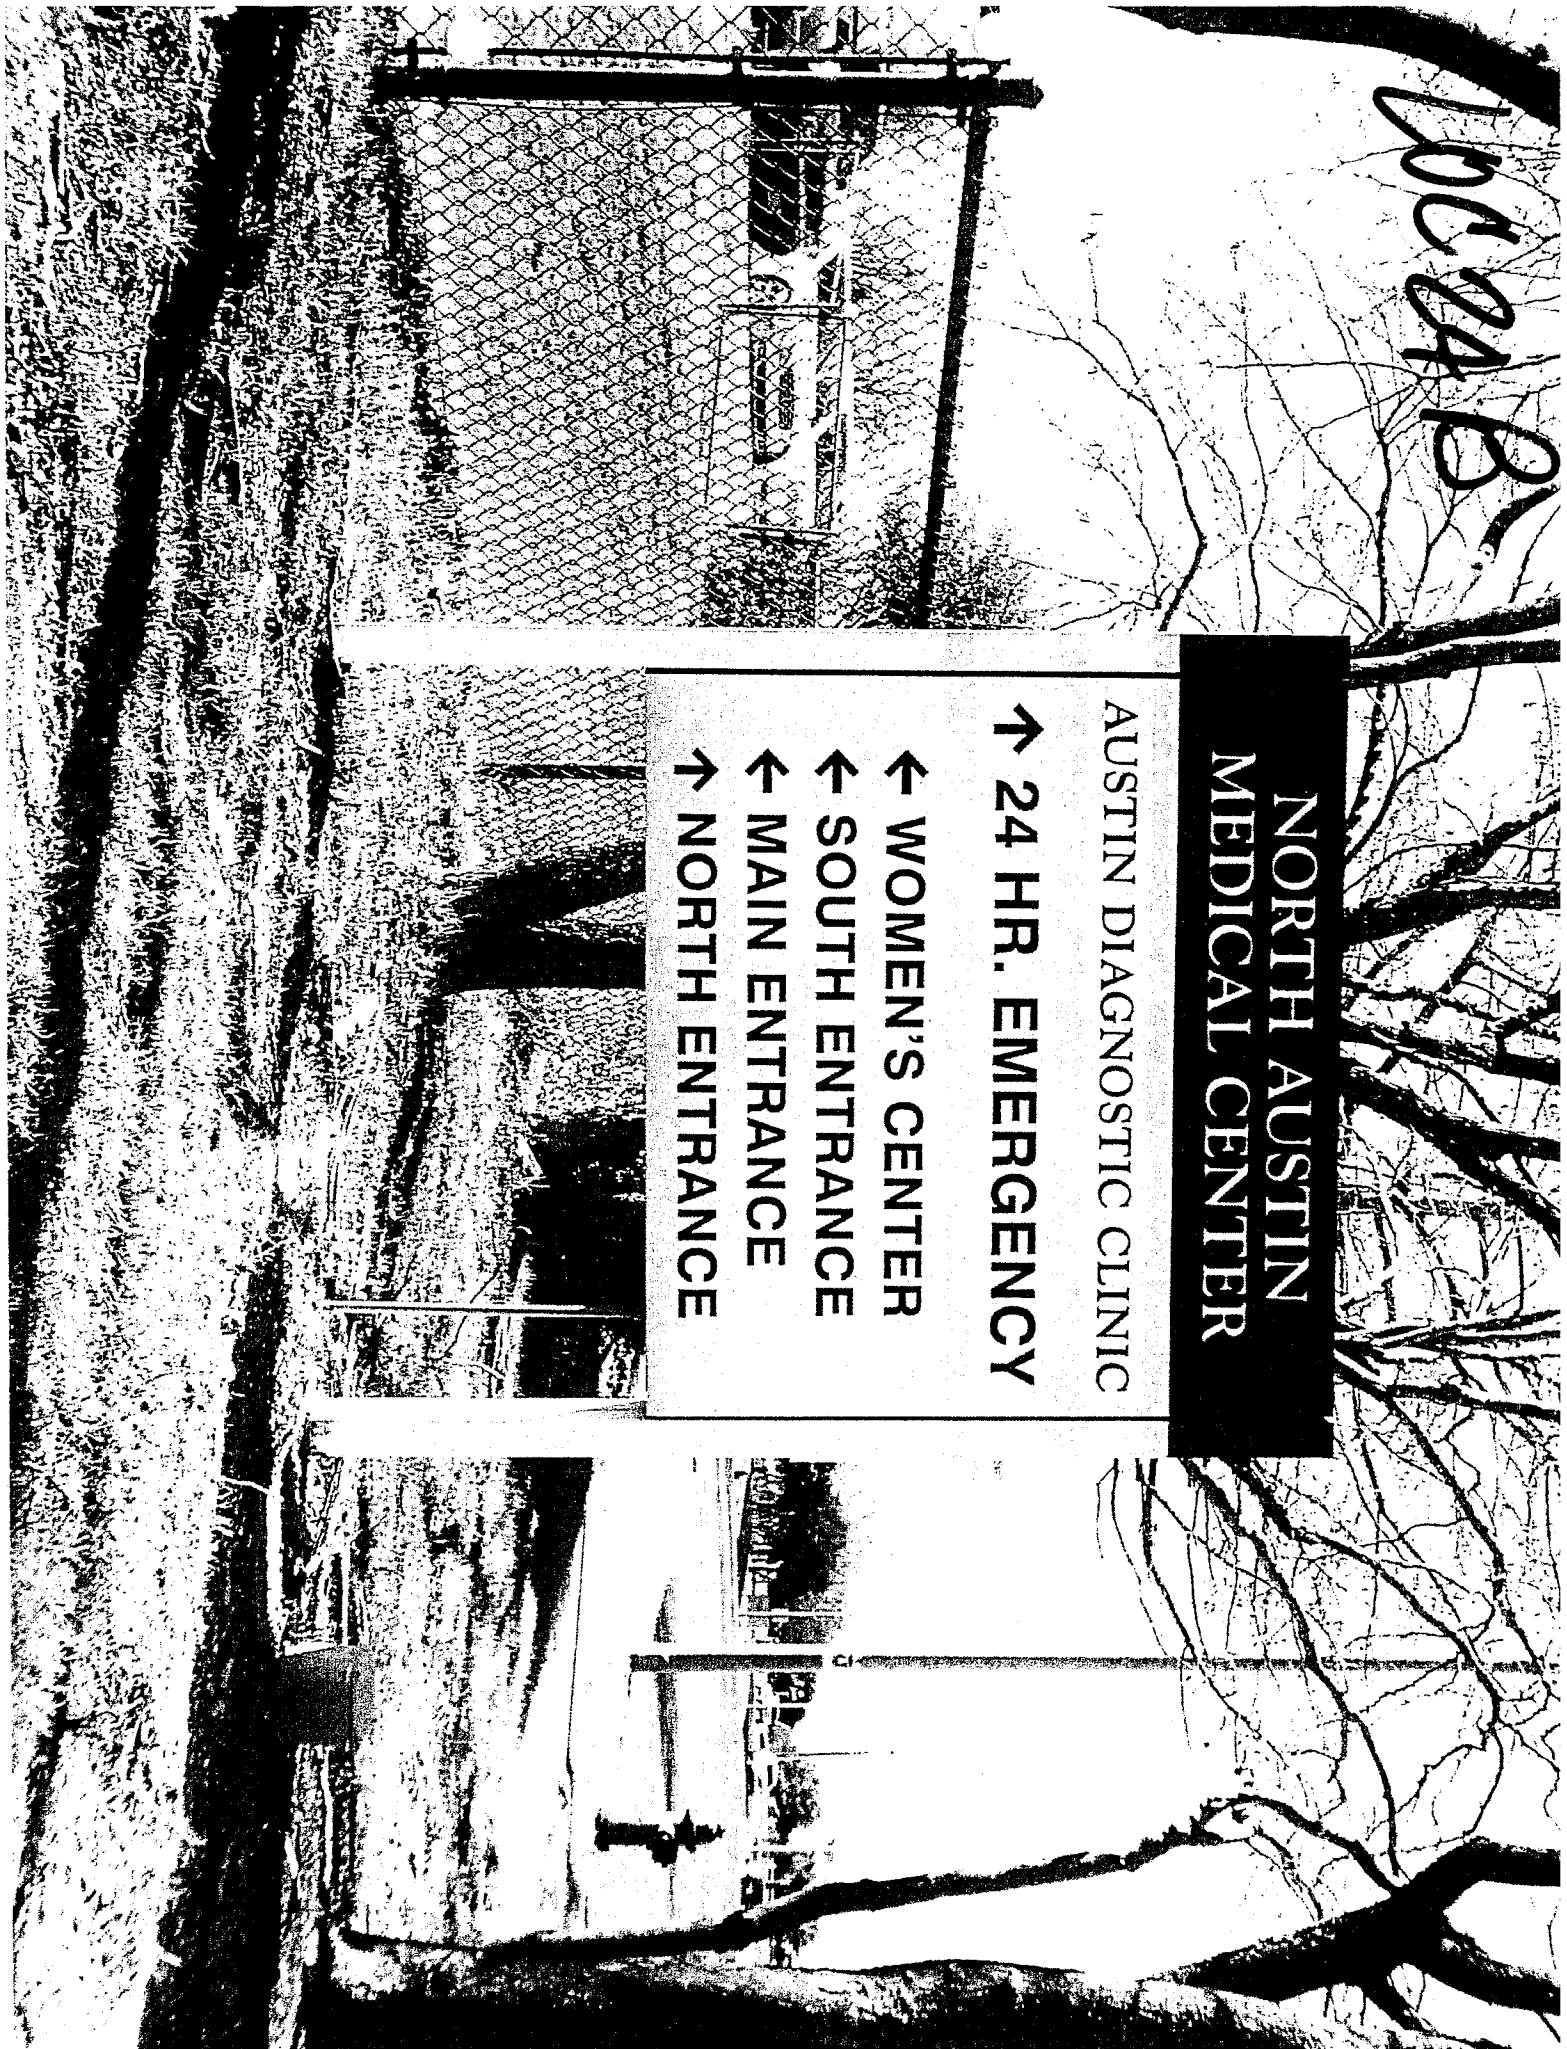



CITY OF AUSTIN
APPLICATION TO SIGN REVIEW BOARD
SIGN VARIANCE

CASE #

26
C16-2015-0002

ROW #

11260510

TAX #

0260130901

WARNING: Filing of this appeal stops all affected construction activity.

(READ)

PLEASE: TYPE AND COMPLETE ALL REQUESTED INFORMATION.

STREET ADDRESS: 12221 N Mo-Pac Expressway Austin, TX 78758

LEGAL DESCRIPTION: Subdivision - 36.3670 A

Lot(s) 1 Block B Outlot Centrum Division The Resub of Blk B & E

I/We Michael A. Hunter on behalf of myself/ourselves as authorized agent for

St. David's North Austin Medical Center affirm that on October, 2014, hereby apply for a hearing before

the Sign Review Board for consideration:

ERECT - ATTACH - COMPLETE - REMODEL - MAINTAIN

Erect a new monument directional sign

in a _____ zoning district and located within the Scenic Roadway
Sign District.

If your variance request is for a reduction in setbacks or height limits, please contact Eben Kellogg with the Electric Utility at (512)322-6050 and send him a scan of your request to eben.kellogg@austinenergy.com before filing your application with this office to discuss your request. The Electric Utility will recommend the board deny your request if it will result in an encroachment into an electric easement or a NESC violation.

NOTE: The Board must determine the existence of, sufficiency of and weight of evidence supporting the findings described below. In order to grant your request for a variance, the Board must first make one or more of the findings described under 1, 2, and 3 below; the Board must then make the finding described in item 4 below. If the Board cannot make the required findings, it cannot approve a sign variance.

Therefore, you must complete each of the applicable Findings Statements as part of your application. Failure to do so may result in your application being rejected as incomplete. Please attach any additional support documents.

VARIANCE FINDINGS: I contend that my entitlement to the requested variance is based on the following findings:

1. The variance is necessary because strict enforcement of the Article prohibits any reasonable opportunity to provide adequate signs on the site, considering the unique features of a site such as its dimensions, landscaping, or topography, because: The new proposed sign is of the
same type and design as previously approved signs for this property in Phase 1
approximately 2 years ago.

OR,

2. The granting of this variance will not have a substantially adverse impact upon neighboring properties, because: We are replacing an existing sign of the same nature in the
same location.

OR,

3. The granting of this variance will not substantially conflict with the stated purposes of this sign ordinance, because: The additional size is needed to convey directions to various
medical facilities within the campus

AND,

4. Granting a variance would not provide the applicant with a special privilege not enjoyed by others similarly situated or potentially similarly situated, because: This is an emergency med-
ical facility that needs to be able to convey directional information to those in need of
emergency medical care.

APPLICANT CERTIFICATE – I affirm that my statements contained in the complete application are true and correct to the best of my knowledge and belief.

Signed Michael A. Hunter Mail Address 7733 Harwell St

City, State & Zip Fort Worth, Texas 76108

Printed Michael A Hunter Phone 817-246-4848 Date 10/30/2014

OWNERS CERTIFICATE – I affirm that my statements contained in the complete application are true and correct to the best of my knowledge and belief.

Signed Michael A. Hunter Mail Address 7733 Harwell St

City, State & Zip Fort Worth, Texas 76108

Printed Michael A. Hunter Phone 817-246-4848 Date 10/30/2014

SIGN SPECIFICATIONS



4420 PolySign Multi-Panel Series
Double Posts and Pylon
Internally Illuminated
Double Sided Graphics *

Support Posts:
Part Code: SP520B* x 8" Rectangular
Color: A46 Off White

Multi-Panel: (Side A & B Logo Panel)
MP2472-423.25" x 72"
Backgrd. Color: A27 Deep Grf@paque)

Illuminated Graphics:

Logo: LTBD (St. David's NAMC)
Size: 9"
Color: A01 White@translucent)

Copy: GaudyOldStyle BD BT
Size: 6 1/4" & 4 1 1/4 (Small Caps)
Color: A01 White@translucent)

Multi-Panels: (Side A Message Panels)
MP272-411.25" x 72"
d. Color: A46 Off White@paque)

MP2072-419.25" x 72"
Backgrd. Color: A46 Off White@paque)

MP3572-434.25" x 72"
Backgrd. Color: A46 Off White@paque)

MP3572-434.25" x 72"
Backgrd. Color: A46 Off White@paque)

Illuminated Graphics:

Arrow: A120
Size: 6"

Color: DayLite@translucent)
Color: A69 American Red@translucent)





Copy: GaudyOldStyle BD BT
Copy: Comic Sans Bold
Size: 5"

Color: DayLite@translucent)
Color: A69 American Red@translucent)

Multi-Panels: (Side B Message Panels)
MP517-250.25" x 72" (Blank) (Qty: 2)
Backgrd. Color: A46 Off White@paque)

go file available for Production Use.

PLAN VIEW

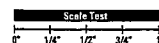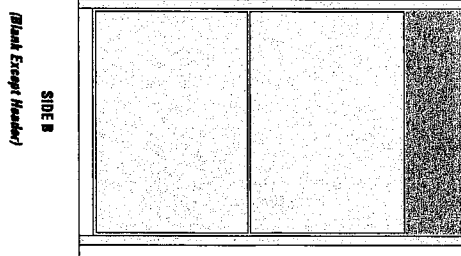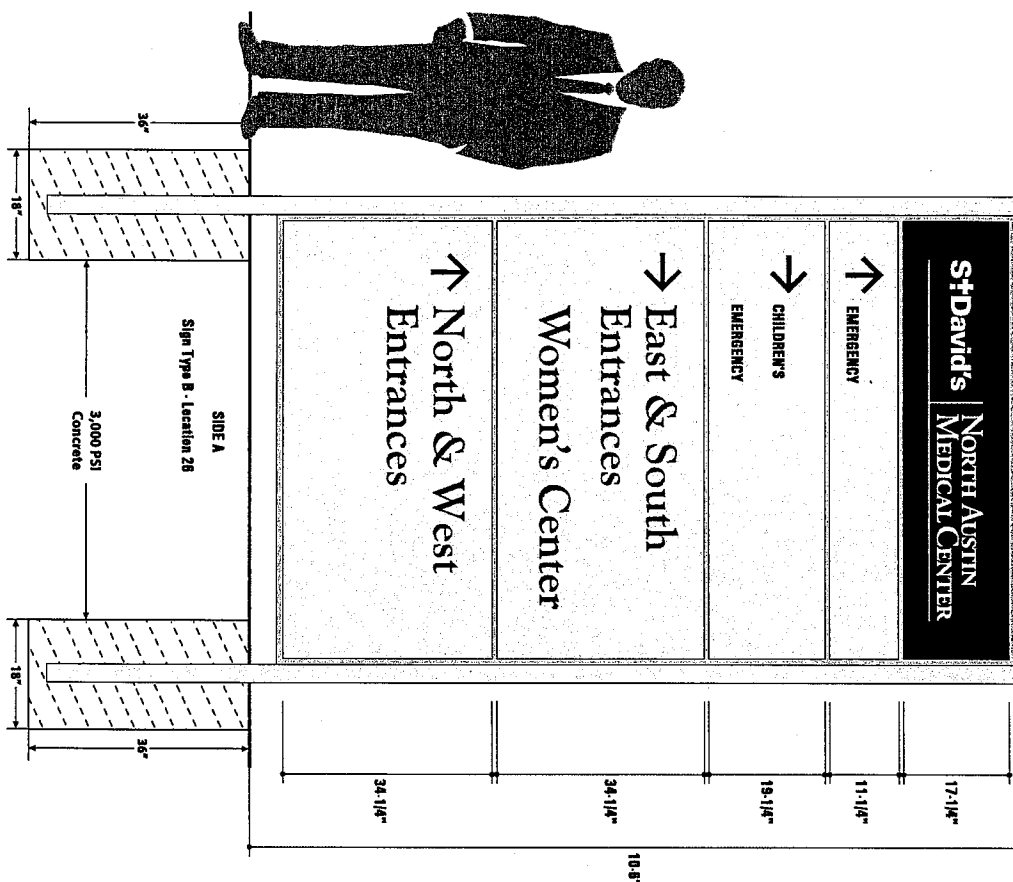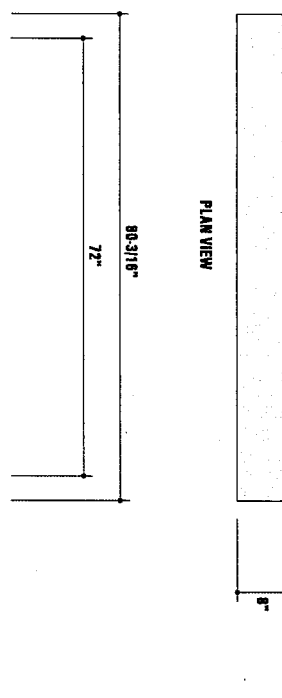

Colors depicted are a general representation of the color specified.
If color selection is critical, please request sample for approval.

Project Reference:	Status:	Date:	Drawn By:	Production Info:	Sign Type:
Project: Children's EMERGENCY - North Austin Med. Ctr.	Original Addition Rev. 1 Revision	19, May 2014 07, July 2014 08, July 2014 25, Aug. 2014	RHK S. Strom S. Strom RHK	Work Order #BBD Approved By: Approved Date:	B Location 26 4420 PolySign Series
Sales Rep: Diana Barcafar CSR/PM:				Customer approval is required prior to production	Scale: 1/2" = 1'-0"


APCO

apcosigns.com

Corporate Headquarters
388 Grant Street SE
Atlanta, GA 30312-2227
Ph: 404.688.9000, Fax: 404.577.3847
Email: sales@apcosigns.com

Removing Existing & Replacing with New
Street Frontage

St. David's N. Austin Medical Center
12221 North Mopac Expwy., Austin, TX 78758

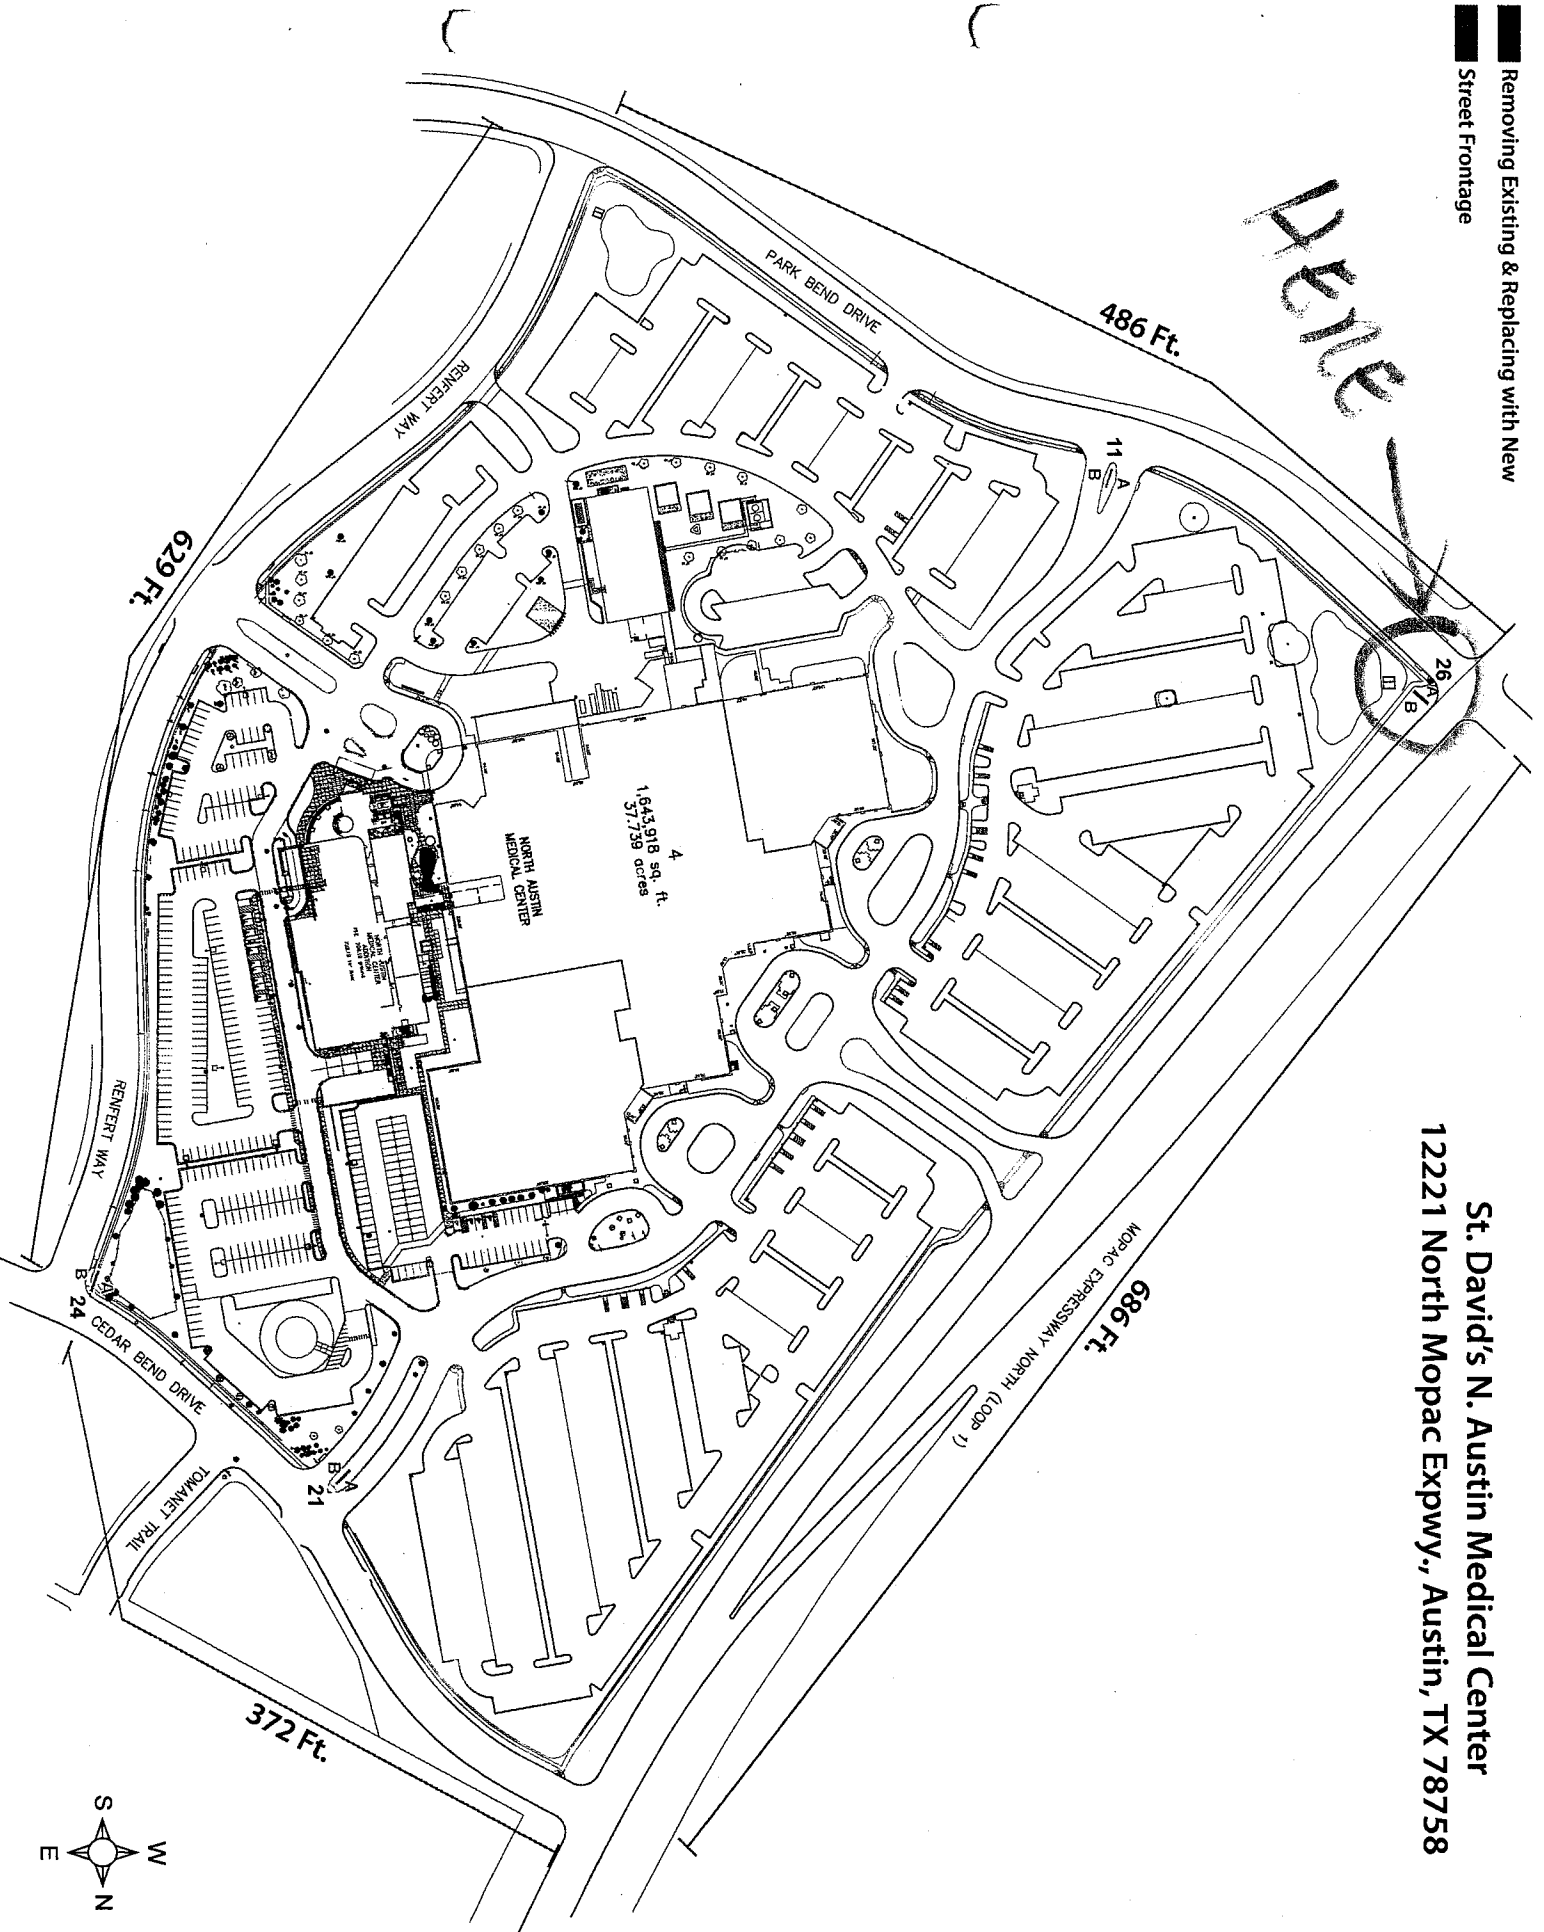

LOCATION 26

CONCRETE

MOP

LOCATED ON
PROPERTY LINE
FRONT LEADING EDGE
OF SIGN


SECTION A-A


FILTRATION POND

SIGN

SIGN LOCATED 12'-0" FROM PROPERTY LINE


PARK

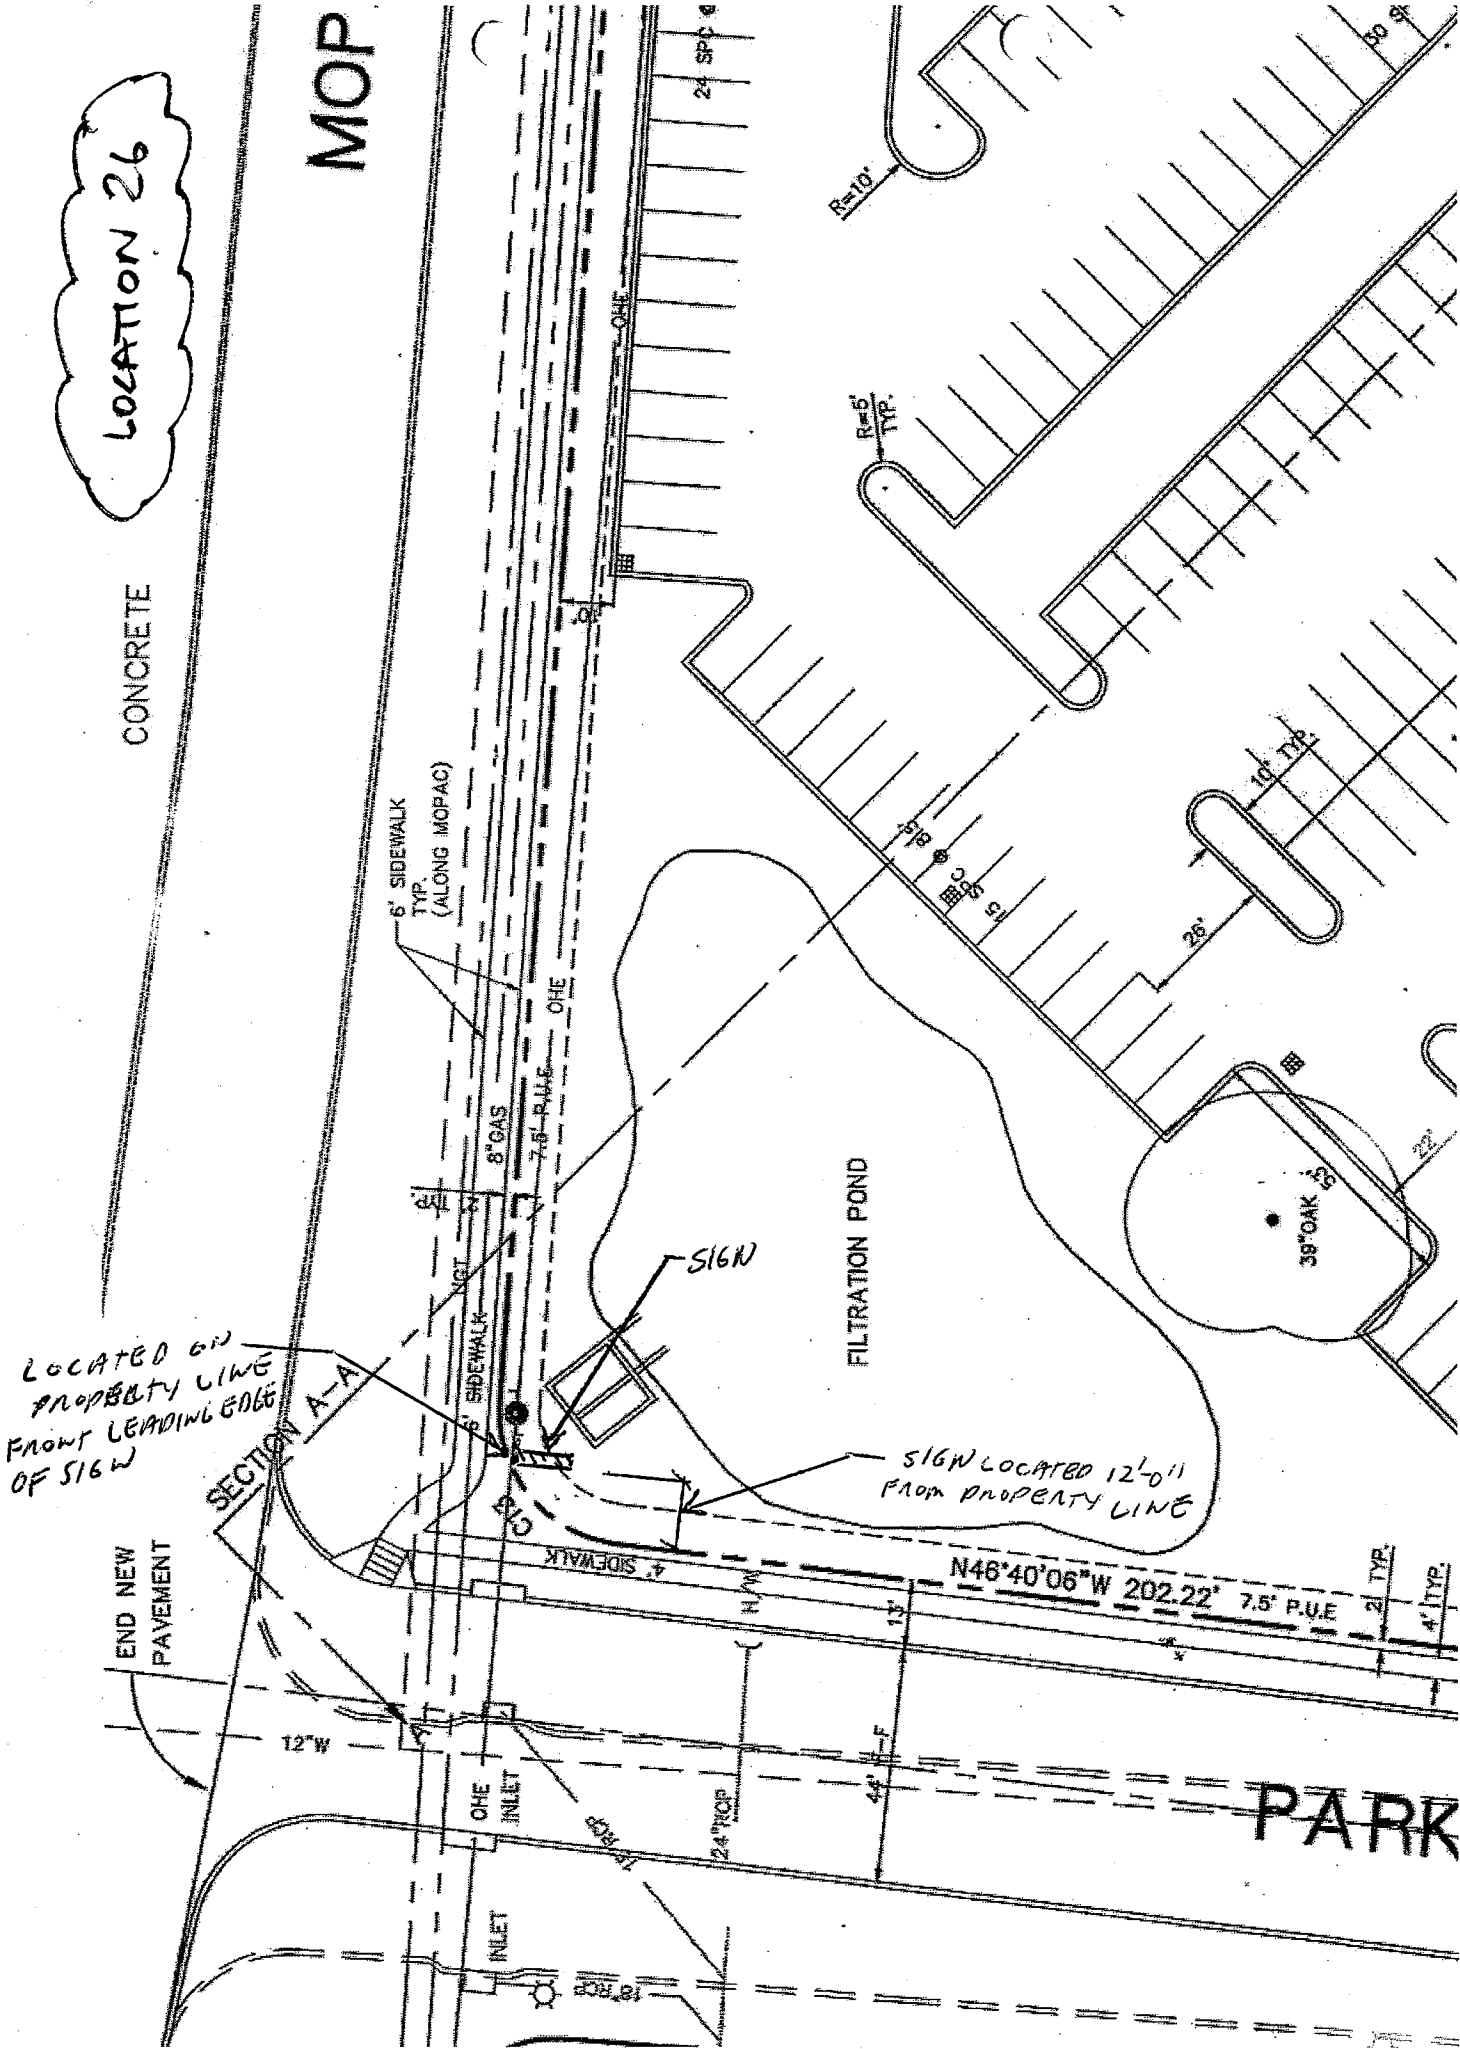

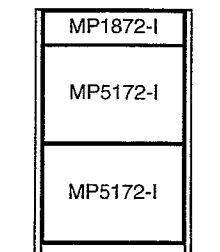

BACK VIEW


Scale: 1/8"=1'-0"

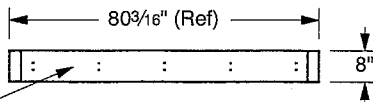

PLAN VIEW

Scale: 1/4"=1'-0"

Aluminum top plate mechanically secured with non-corrosive countersunk screws

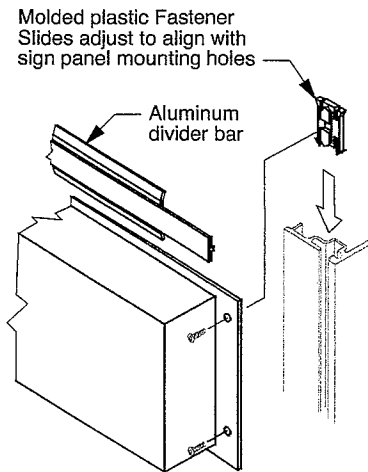

DETAIL '1': FASTENER SLIDE


Scale: None

F72T12/D/HO Fluorescent lamp (Qty.13)

SPS200 Rectangular aluminum support post (Qty.2)


Structural aluminum channel insert (1 per post)

Concrete footings by installer (See Note 3)

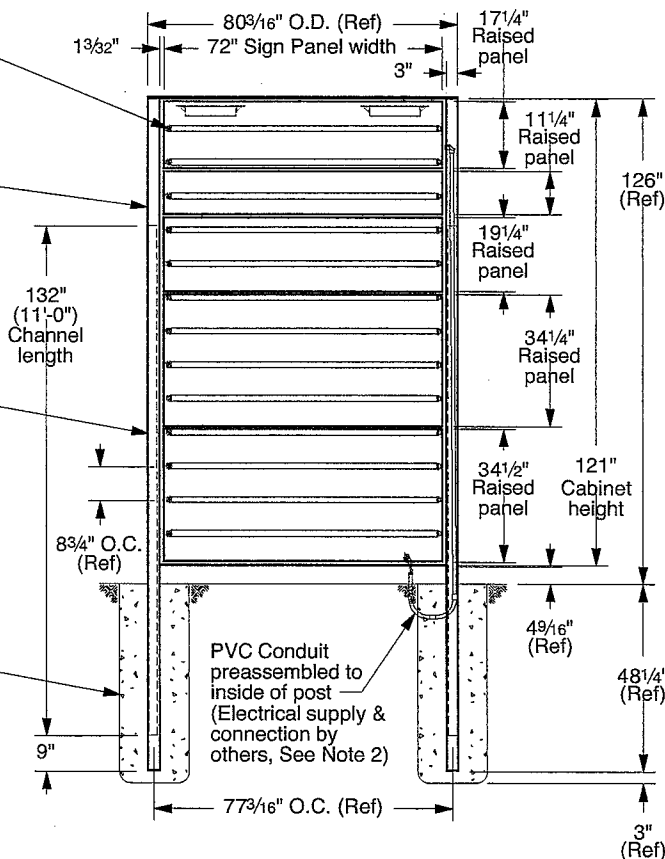

FRONT VIEW

Scale: 1/4"=1'-0"
(Side 'A' Shown)

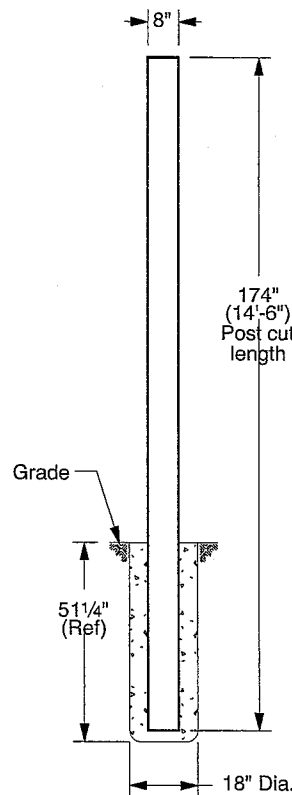

END VIEW

Scale: 1/4"=1'-0"

NOTES:

1. Refer to presentation drawing and/or work order for colors, graphics specifications and sign panel sizes.
2. ___ V Electrical supply, conduit and associated fittings are by others. Installer to increase footing size as required to route conduit. Electrical connection performed by certified persons.
3. Footings are shown for reference only. Actual design and installation performed by certified persons based on local codes and geographic practices.
4. Lifting bolts are provided to assist with sign installation. Lifting brackets are accessible by removing post caps. Remove bolts after installation and replace post caps.

Location(s)

26

**APPROVAL
REQUIRED**

BY: _____

DATE: _____




Atlanta, Georgia USA • Phone: (404) 688-9000 • Web: www.apcosigns.com

All Design Rights Reserved

Customer: North Austin Medical Center
Project: Exterior Main Entrance
Location '26' - Elevation Views
Product: 4420 MultiPanel PolySign
Double Post Mount, Illuminated


Date: 10/01/14
Drawn: WWD
Scale: As Shown
Coord.: DTS
W.O.#: 437581

Sheet: 26.a

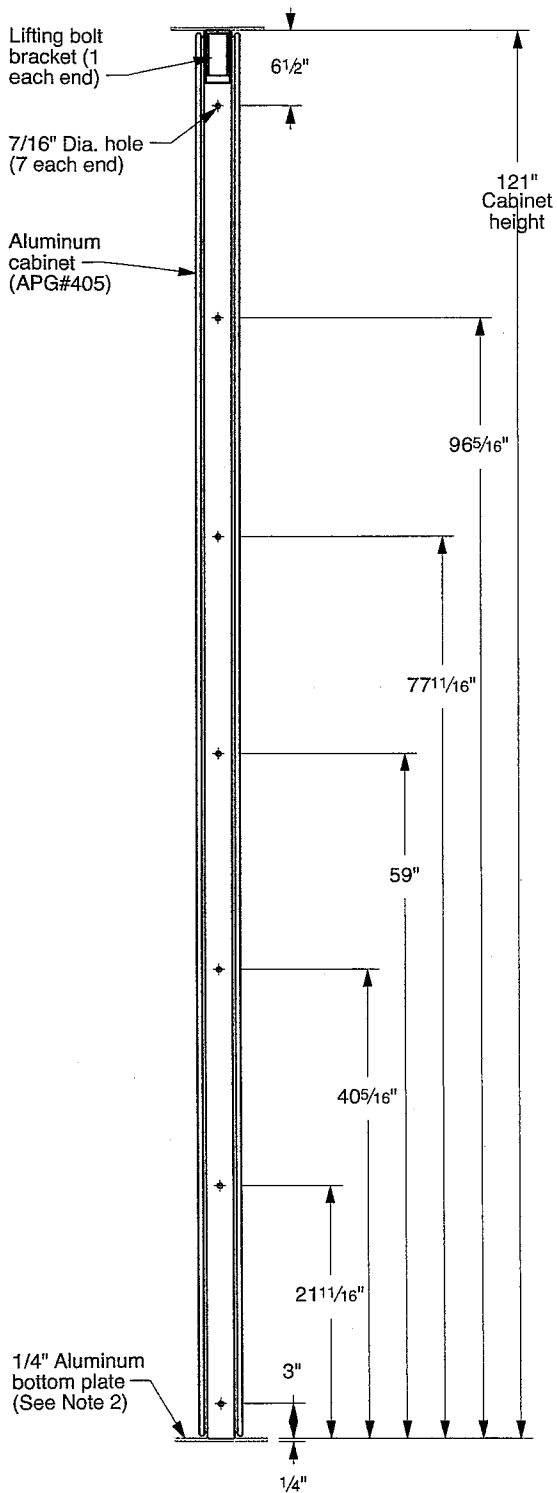


END VIEW: SIGN CABINET

Scale: 3/4"=1'-0"
(Left end shown: Right end typical)

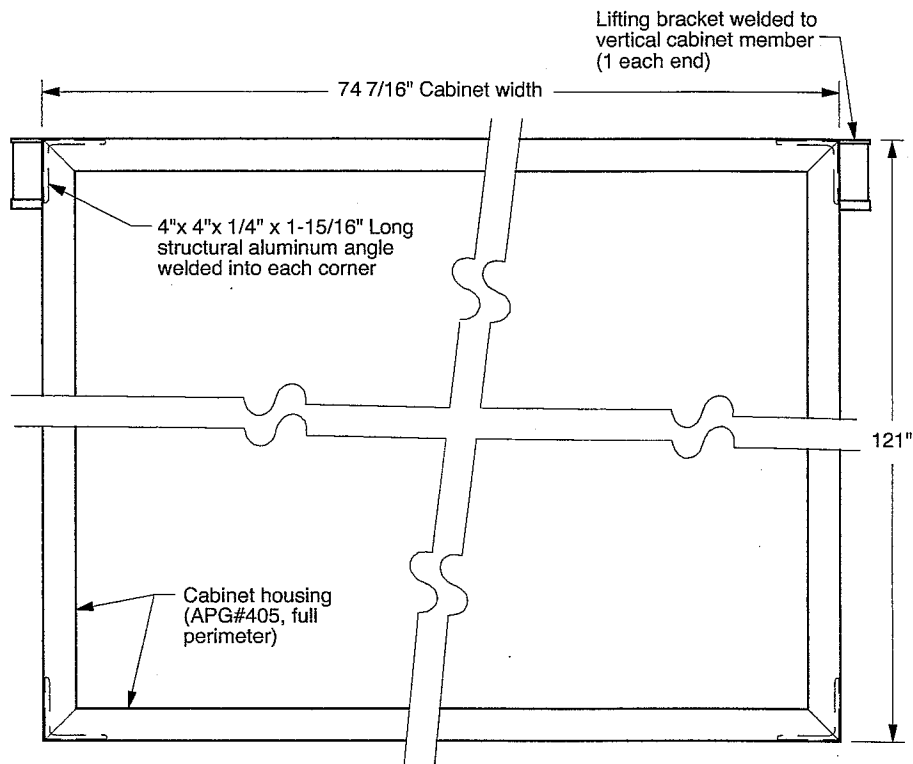

FRONT VIEW: SIGN CABINET

Scale: 1"=1'-0"

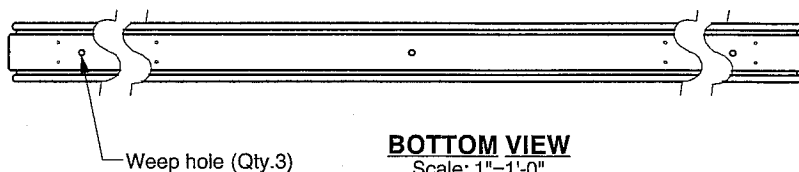

BOTTOM VIEW

Scale: 1"=1'-0"

Location(s)

26

NOTES:

1. Refer to presentation drawing and/or work order for colors, graphics specifications and sign panel sizes.

**APPROVAL
REQUIRED**

BY: _____

DATE: _____



apcosigns.com


Atlanta, Georgia USA • Phone: (404) 688-9000 • Web: www.apcosigns.com

All Design Rights Reserved


Customer: North Austin Medical Center
Project: Exterior Main Entrance
Location '26' - Cabinet Details
Product: 4420 MultiPanel PolySign
Double Post Mount, Illuminated

Date: 10/01/14
Drawn: WWD
Scale: As Shown
Coord.: DTS
W.O.#: 437581


Sheet: 26.b

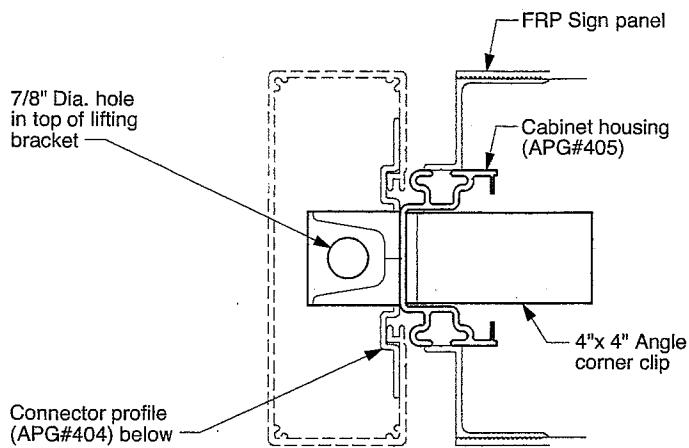


SECTION: "26.c1"
Scale: 1/4"=1"

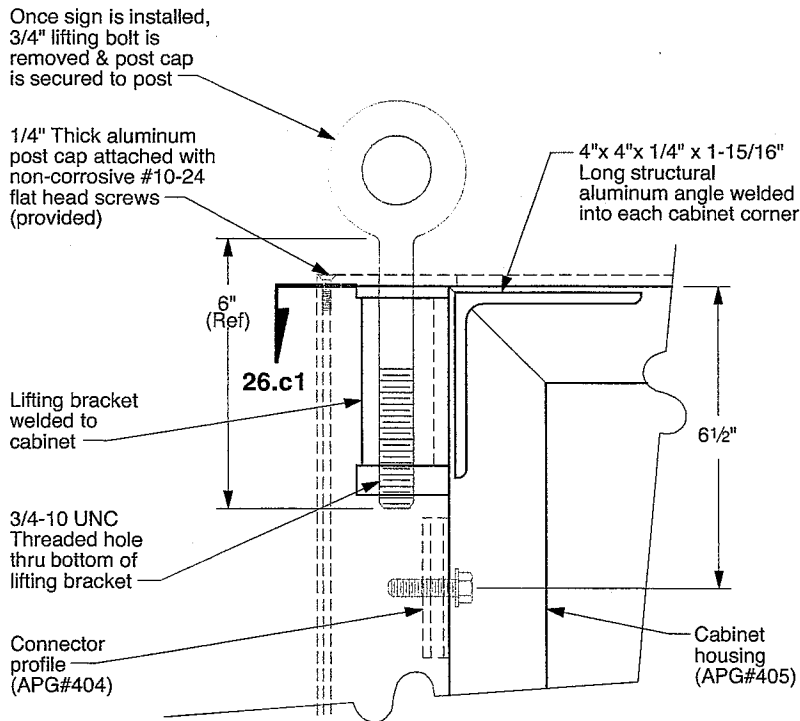


**FRONT SECTION VIEW @
LIFTING BRACKET**
Scale: 1/4"=1"

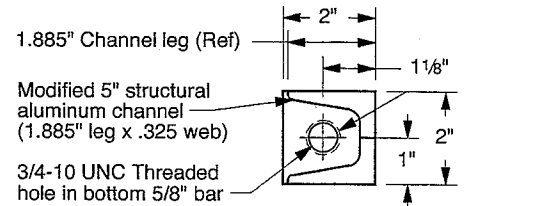


SECTION: "26.c2"
Scale: 1/4"=1"

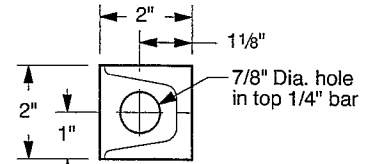

PLAN VIEW
Scale: 1/4"=1"

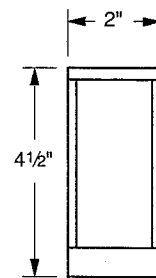

END VIEW
Scale: 1/4"=1"

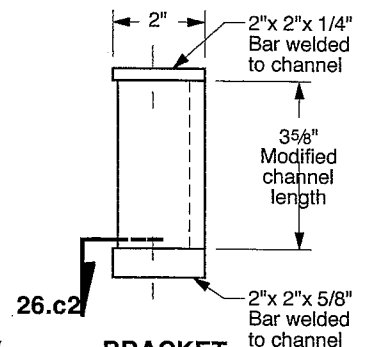

**BRACKET
FRONT VIEW**
Scale: 1/4"=1"

NOTES:

1. Lifting bolts are provided to assist with sign installation. Lifting brackets are accessible by removing post caps. In order to maintain structural integrity of the cabinet, use spreader beam and maintain a 90° angle between cabinet and both lifting bolts. Remove bolts after installation and replace post caps.



Atlanta, Georgia USA • Phone: (404) 688-9000 • Web: www.apcosigns.com

All Design Rights Reserved

Customer: North Austin Medical Center
Project: Exterior Main Entrance
Location '26' - Lifting Bracket Details
Product: 4420 MultiPanel PolySign
Double Post Mount, Illuminated

Date: 10/01/14
Drawn: WWD
Scale: As Shown
Coord.: DTS
W.O.#: 437581


Sheet: 26.c

Location(s)
26


**APPROVAL
REQUIRED**

BY: _____


DATE: _____

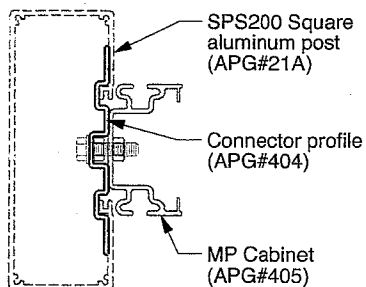

SECTION: "26.d1"
Scale: 3/16"=1"

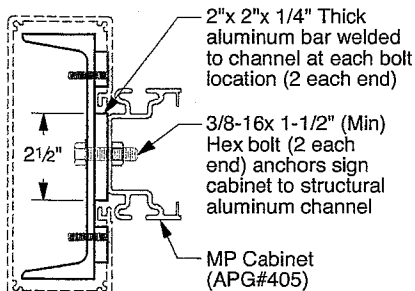

SECTION: "26.d2"
Scale: 3/16"=1"

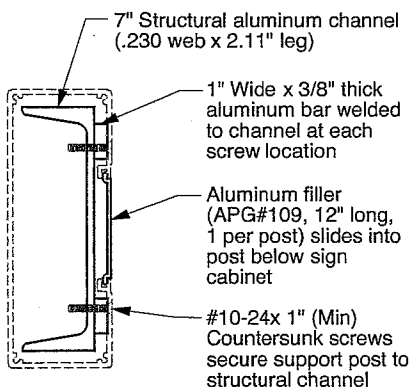


SECTION: "26.d3"
Scale: 3/16"=1"

26.d1

26.d2

26.d3

FRONT VIEW
Scale: 1/2"=1'-0"

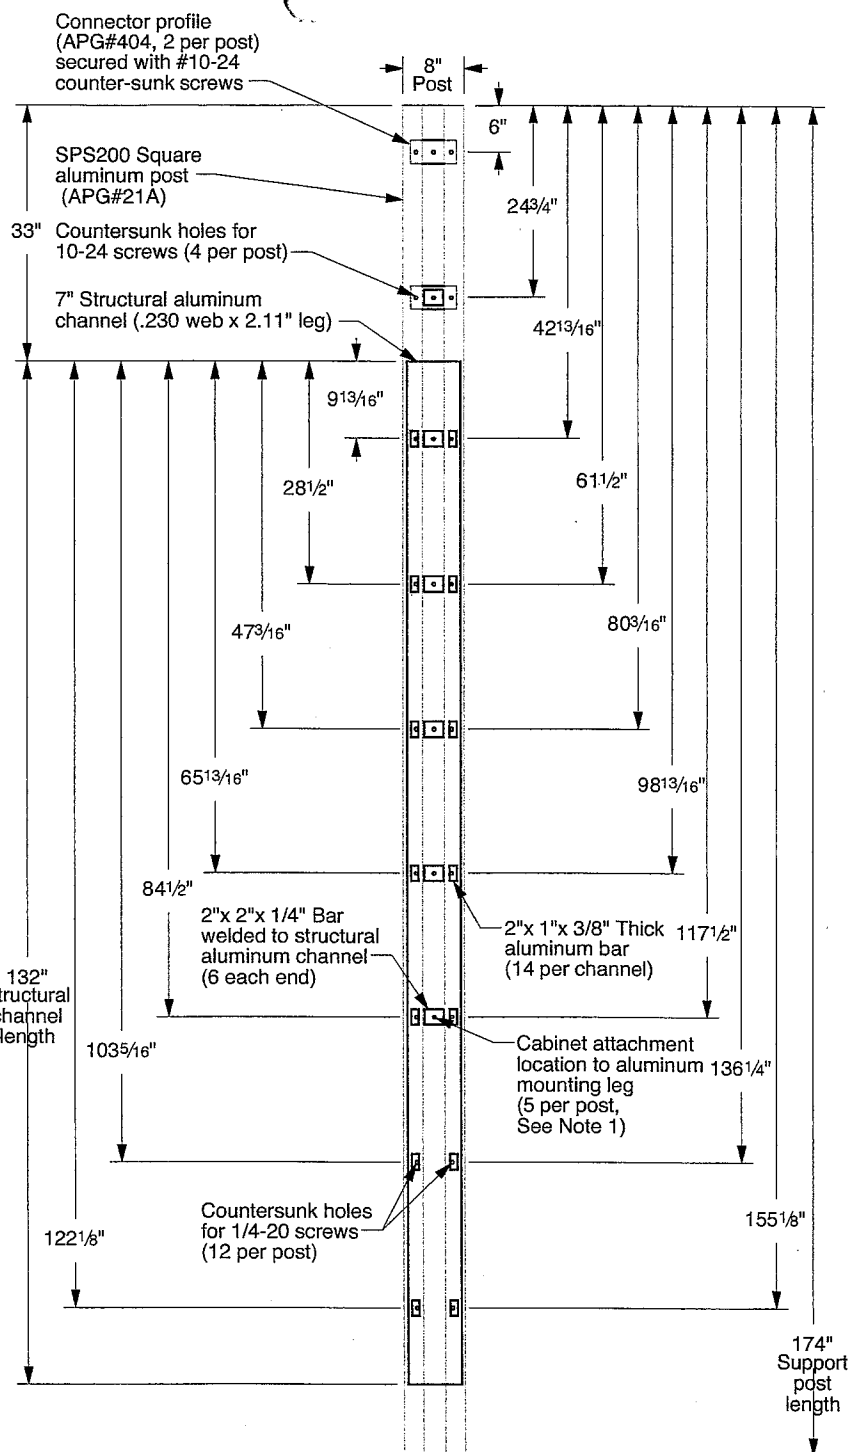

**INSIDE VIEW:
STRUCTURAL CHANNEL**
Scale: 1/2"=1'-0"

NOTES:

1. Lifting bolts are provided to assist with sign installation. Lifting brackets are accessible by removing post caps. In order to maintain structural integrity of the cabinet, use spreader beam and maintain a 90° angle between cabinet and both lifting bolts. Remove bolts after installation and replace post caps.

Location(s)
26

**APPROVAL
REQUIRED**

BY: _____
DATE: _____






Atlanta, Georgia USA • Phone: (404) 688-9000 • Web: www.apcosigns.com

All Design Rights Reserved

Customer: North Austin Medical Center
Project: Exterior Main Entrance
Location '26' - Structural Channel Details
Product: 4420 MultiPanel PolySign
Double Post Mount, Illuminated

Date: 10/01/14
Drawn: WWD
Scale: As Shown
Coord.: DTS
W.O.#: 437581

Sheet: 26.d

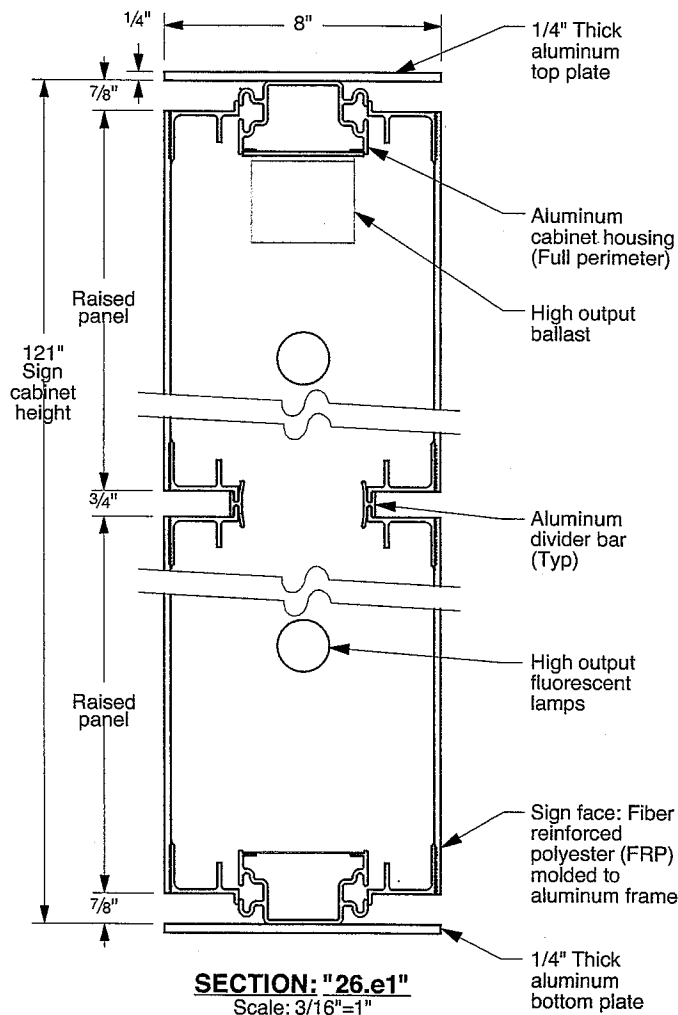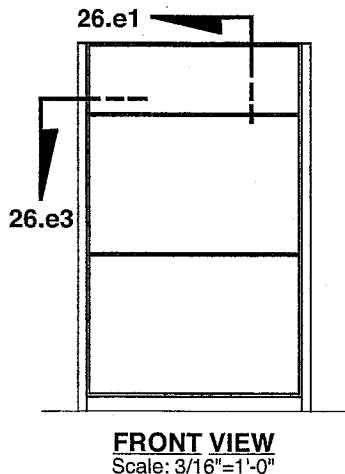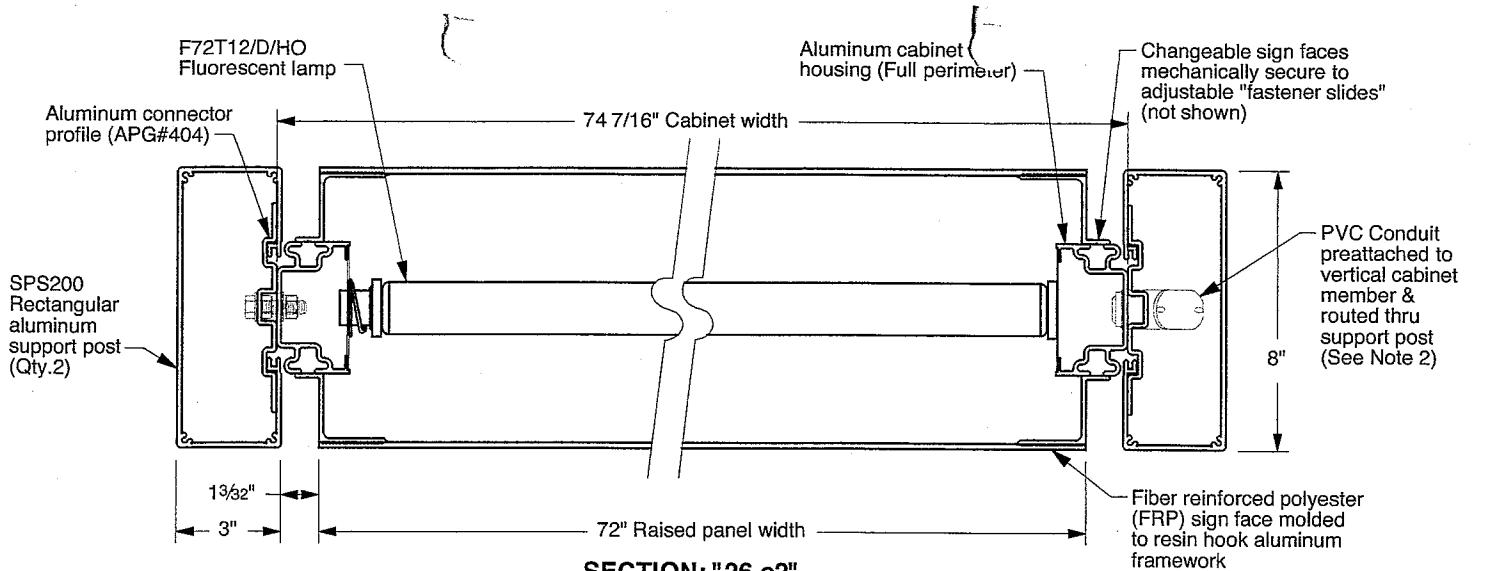

NOTES:

1. Refer to presentation drawing and/or work order for colors, graphics specifications and sign panel sizes.
2. ___V Electrical supply, conduit and associated fittings are by others. Installer to increase footing size as required to route conduit. Electrical connection performed by certified persons.

Location(s)

26

**APPROVAL
REQUIRED**

BY: _____

DATE: _____




Atlanta, Georgia USA • Phone: (404) 688-9000 • Web: www.apcosigns.com

All Design Rights Reserved

Customer: North Austin Medical Center
Project: Exterior Main Entrance
Location '26' - Section Views
Product: 4420 MultiPanel PolySign
Double Post Mount, Illuminated






Date: 10/01/14
Drawn: WWD
Scale: As Shown
Coord.: DTS
W.O.#: 437581

Sheet: 26.e

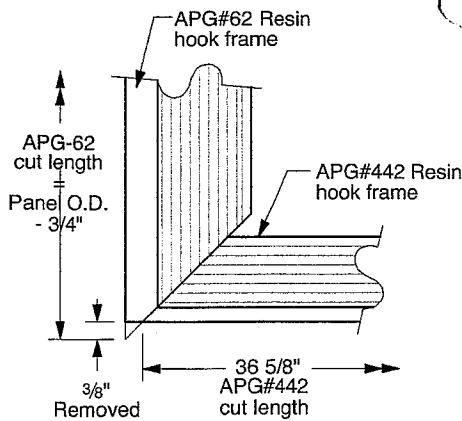

TYPICAL CORNER DETAIL

Scale: 1/4"=1"

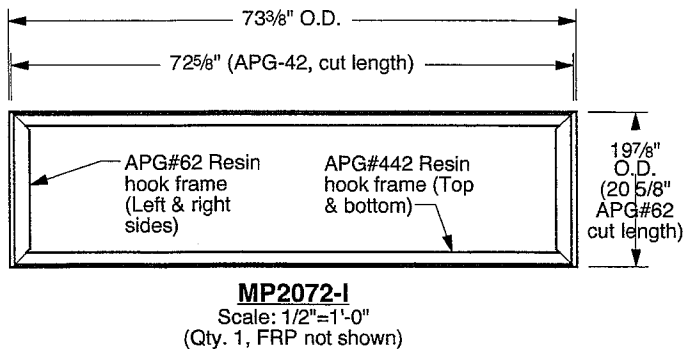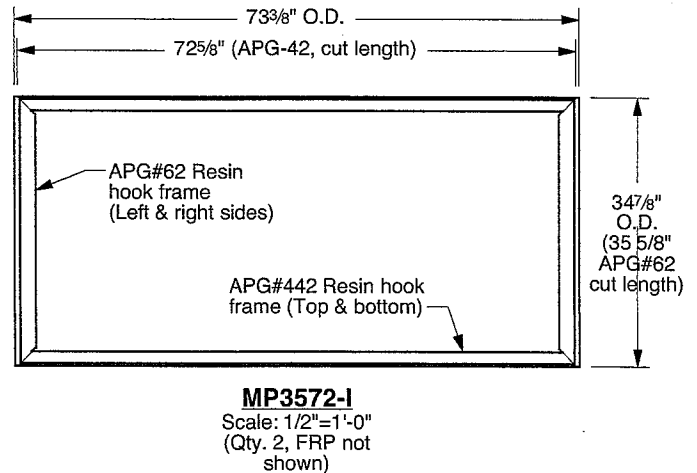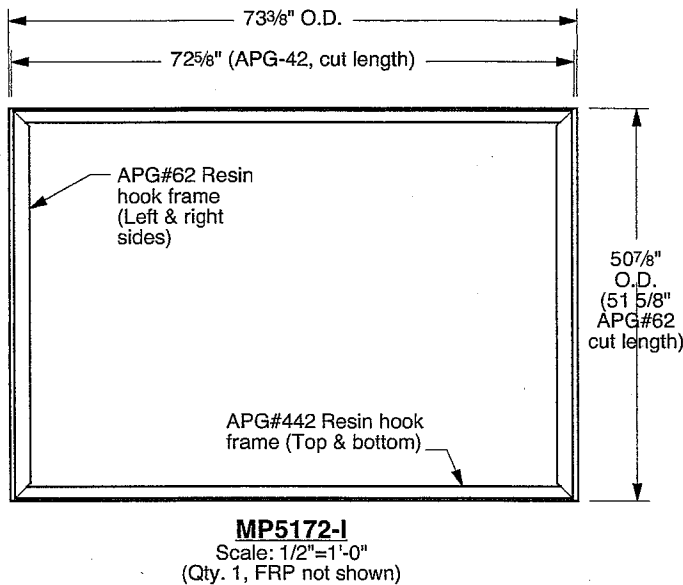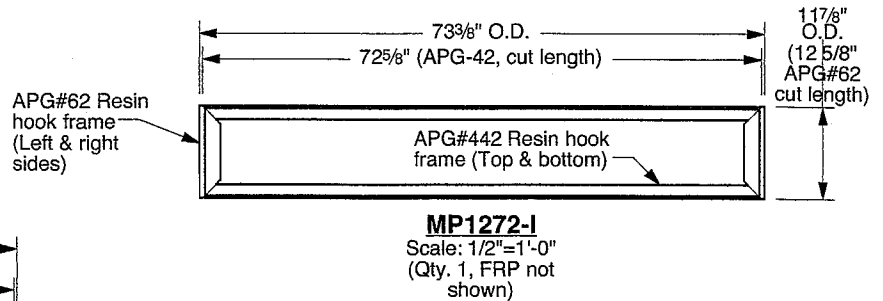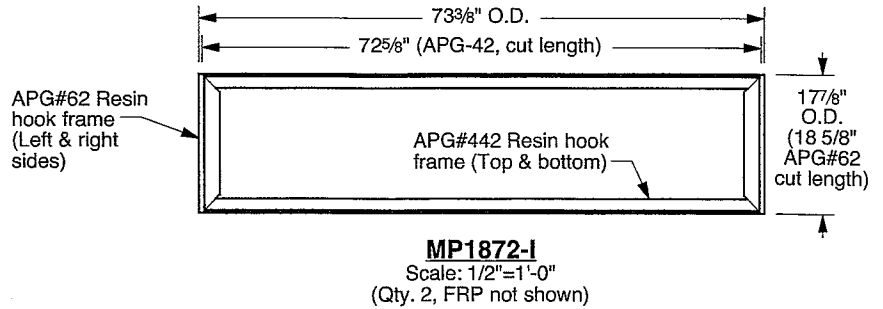

Location(s)
26

NOTES:

1. Refer to presentation drawing and/or work order for colors, graphics specifications and sign panel sizes.

**APPROVAL
REQUIRED**

BY: _____
DATE: _____




Atlanta, Georgia USA • Phone: (404) 688-9000 • Web: www.apcosigns.com

All Design Rights Reserved


Customer: North Austin Medical Center
Project: Exterior Main Entrance
Location '26' - Sign Panel Details
Product: 4420 MultiPanel PolySign
Double Post Mount, Illuminated

Date: 10/01/14
Drawn: WWD
Scale: As Shown
Coord.: DTS
W.O.#: 437581

Sheet: 26.f

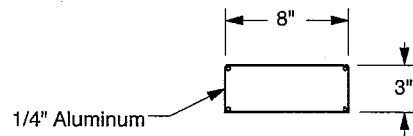

WJ POST CAP
Scale: 1"=1'-0"

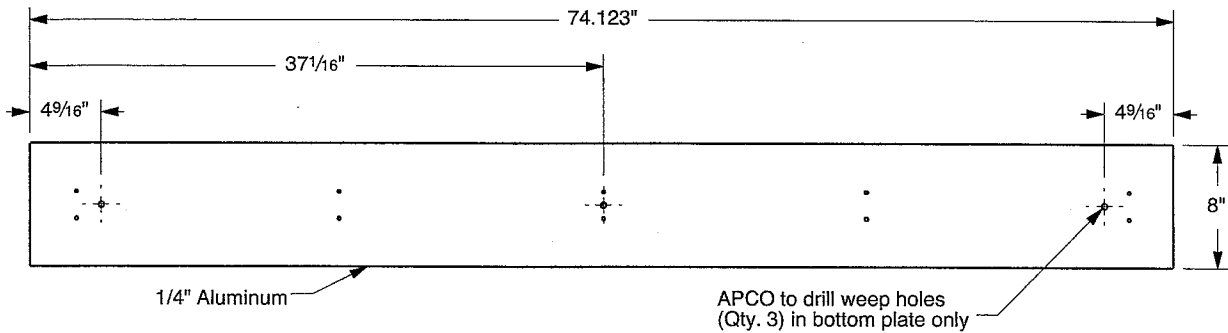

WJ TOP/BOTTOM PLATE
Scale: 1"=1'-0"

Location(s)
26

NOTES:

1.

**APPROVAL
REQUIRED**

BY: _____

DATE: _____



Atlanta, Georgia USA • Phone: (404) 688-9000 • Web: www.apcosigns.com

All Design Rights Reserved

Customer: North Austin Medical Center
Project: Exterior Main Entrance
Location '26' - Water-Jet Parts
Product: 4420 MultiPanel PolySign
Double Post Mount, Illuminated

Date: 10/01/14
Drawn: WWD
Scale: As Shown
Coord.: DTS
W.O.#: 437581

Sheet: 26.g

LOC. 26

**NORTH AUSTIN
MEDICAL CENTER**

AUSTIN DIAGNOSTIC CLINIC

↑ 24 HR. EMERGENCY

↑ NORTH ENTRANCE

↑ MAIN ENTRANCE

→ SOUTH ENTRANCE

→ WOMEN'S CENTER

